KING COUNTY

CITY OF ISSAQUAH

WASHINGTON

EAST LAKE SAMMAMISH PARKWAY SE IMPROVEMENTS (SE 56TH STREET TO SE ISSAQUAH-FALL CITY ROAD)

CONTACT PERSONNEL

| NAME | AGENCY | PHONE No. |
|----------------|--|--------------|
| GARY COSTA | CITY TRANSPORTATION MANAGER | 425-837-3443 |
| KELLY PURNELL | PUGET SOUND ENERGY MUNICIPAL CONSTRUCTION PLANNER | 425-462-3488 |
| ANDY SWAYNE | PUGET SOUND ENERGY | |
| LISA TOBIN | SAMMAMISH PLATEAU WATER AND SEWER DISTRICT | |
| JIM BROOKE | COMCAST | 253-261-2895 |
| PETER STOCKTON | CENTURYLINK | 206-345-3963 |
| BRIAN SOURWINE | GRAY & OSBORNE, INC. | 206-284-0860 |

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FEDERAL AID NUMBER: STPUL-1915(009)
FEDERAL CONTRACT NUMBER: LA8153

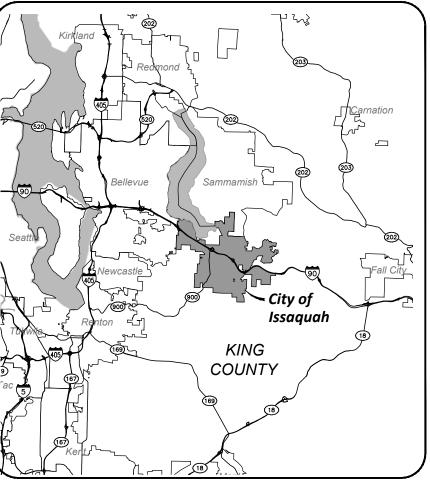
CITY OFFICIALS

AVA FRISINGER MAYOR MARY LOU PAULY COUNCILMEMBER FRED BUTLER COUNCILMEMBER **EILEEN BARBER** COUNCILMEMBER **JOSHUA SCHAER** COUNCILMEMBER **STACY GOODMAN** COUNCILMEMBER **PAUL WINTERSTEIN** COUNCILMEMBER COUNCILMEMBER **TOLA MARTS BOB HARRISON CITY ADMINISTRATOR TINA EGGERS** CITY CLERK SHELDON LYNNE PUBLIC WORKS ENGINEERING DIRECTOR TODD CHRISTENSEN SENIOR ENGINEER



PRELIMINARY 1/22/2014





VICINITY MAP

CITY OF ISSAQUAH
PUBLIC WORKS ENGINEERING
CITY HALL NORTHWEST
1775 12TH AVENUE NW
ISSAQUAH, WASHINGTON 98027

JANUARY 2014



PROJECT LOCATION MAP

SCALE: 1"=600'

SLOPE SOUTH

SQUARE STATION

STANDARD THRUST BLOCK TOP OF CURB

THREADED

VERTICAL

WITHOUT

SQ STA STD TB TC TEL TESC THRD THRU TYP

VFRT

SQUARE FEET SHEET

SPECIFICATIONS

TELEPHONE
TEMPORARY EROSION AND SEDIMENT CONTROL

WASHINGTON STATE DEPARTMENT OF TRANSPORTATION

SHEET: XX OF: JOB NO.: 13570 DWG: LEGEND

SAMMAMISH PARKWAY MPROVEMENTS

LAKE

EAST

3OL LEGEND, I MAP

ISSAQUAH WASHING

P

CITY

PRELI

DESCRIPTION

APPROXIMATE DOORWAY

BUILDING

LOCATION

BUS STOP

SIGN

RIP RAP

SHRUB

TREE (CONIFER)

WFTI AND

TREE (DECIDUOUS)

EDGE OF CREEK/STREAM

BUILDING EAVES

MAIL BOX (NOTED)


MODULAR BLOCK WALL

SEGMENTAL BLOCK WALL

| VERTIC | S N ZONE CAL DATUM | | | SURVEY CONTROL TABLE | | | |
|--------------|-----------------------|------------|----------------|---|--|--|--|
| NAVD | | FACTINO | - Flori | DECODIDATION | | | |
| POINT 106 | 203634.74 | 1340975.20 | 54.92 | DESCRIPTION SFNT, BCE TRAV PT. TAG & MAG NAIL. SW'LY COR INTX SE 56TH ST/221 PL SE. +/- 10' S-SE FROM CROSSWALK. 7. | | | |
| 107 | 203160.89 | 1341234.76 | 57.06 | N-NW FROM END OF SIDEWALK. SSN, 14.5' S-SE FROM N'LY END OF SIDEWALK. 2.7' E'LY FROM TBC. +/- 12' W-NW FROM PP ON BUSH LANE. JUST | | | |
| 108 | 202672.58 | 1341454.31 | 58.45 | OF INTEGRITY AUTOMOTIVE. SSN, 3.3' E OF E'LY TBC ON "BUSH LANE" 221ST PL. 11' S-SW FROM PP. +/-45' S OF S ENTRANCE TO CLOSED | | | |
| 109 | 202011.96 | 1341602.35 | 57.92 | BUSINESS LOT. JUST WEST OF CREEK CROSSING. SSNT, 0.8' NE FROM SW EOP. +/- 36' NW FROM SE 61ST. JUST NORTH OF ESI LOT. | | | |
| 110 | 201592.90 | 1341924.19 | 63.12 | SFMC, 1 3/4" BRASSY W/NO PUNCH. IN 4X4 CONC POST DOWN 0.4'. | | | |
| 111 | 201711.12 | 1342535.09 | 67.08 | SSNT, 2.5' E-SE FROM TBC ON E'LY CORNER SE 62ND ST/ ELK SAMMAMISH PKWY SE. +/-, 13.5' NW FROM DMH. +/- B' SW FROM TSJB. | | | |
| 112 | 201276.62 | 1342867.55 | 68.94 | SFNT, PACE TAG & NAIL. IN TRAFFIC ISLAND ALONG N. SIDE E.LK SAMM. PKWY. S OF HOME DEPOT, N. OF WALGREENS. | | | |
| 113 | 200946.87 | 1343113.00 | 69.33 | SSNT, 2' N. OF TEC ON N'LY COR. INTX. OF E. LK SAMM. PKWY SE & SE ISSAQUAH-FALL CITY ROAD. ◎ NW EDGE OF NW'LY ADA RAMP. | | | |
| 114 | 200881.86 | 1343116.87 | 68.71 | SFMC, BRASS TACK SET IN CONC. DOWN 1.25' IN CASE. C/L INTX OF E. LK. SAMM. PKWY & SE ISSAQUAH-FALL CITY RD. | | | |
| 115 | 200995.15 | 1343349.01 | 74.49 | SFMC, BRASS PIN/NAIL IN 3X3 CC POST. @ENTRANCE TO EVERGREEN AUTOBODY. 8.5' S. OF RCE. | | | |
| 116 | 202221.52 | 1342038.17 | 63.19 | SSNT, 2.8' NE FROM SW EOP. 5.8' NE FROM NE PVC. ALON- E.LK. SAMM. PKWY. E'LY SIDE OF ENTRANCE TO BUDGET RENTAL. +/- 14' NW FROM WFHT. | | | |
| 117 | 202872.93 | 1341724.01 | 59.25 | SSNT, 2.5' E OF W. RWB ALONG E.LK.SAMM.PKWY. 4.5' E'LY FROM TSPL ❷ INTX W/BLACK NUGGET RD. | | | |
| 118 | 203620.02 | 1341497.81 | 54.34 | SSNT, SW COR INTX SE 56 ST & E.LK.SAMM.PKWY. @ SE CO ADA RAMP. +/- 8.5' SE FROM TSLP. | | | |
| 119 | 203678.94 | 1341531.49 | 53.51 | SFMC, 1 3/4" BRASSY W/PUNCH IN 4X4 CONC POST DOWN 0.55'. C/L INTX SE 56TH ST & E.LK.SAMM. PKWY. | | | |
| 126 | 201411.74 | 1340646.43 | 62.65 | SSNT, © N. EOP OF TRAIL. +/- 36' W OF E. END OF FGT/BLUFF. | | | |
| 127 | 201505.20 | 1341116.89 | 64.01 | SSNT, 1' N OF S. EOP. 8.5' E'LY OF E'LY SIDE OF FOOT BRIDGE. | | | |
| 128 | 201689.36 | 1341258.62 | 58.68 | SSS, 60D NAIL IN WETLAND AREA. | | | |
| 129 | 201667.45 | 1341488.34 | 56.88 | SSS, 60D NAIL W/WHISKERS IN WETLAND AREA. | | | |
| 139 | 201700.77 | 1341244.36 | 59.33 | SFRC, 1/2" REBAR W/YPC "LS 33487 BOGDON" SFRC, 1/2" REBAR W/OPC "LS 33487 BOGDON" | | | |
| 140 | 201695.47 | 1341486.61 | 57.11 58.24 | SFRC, 1/2" REBAR W/YPC "LS 33487 BOGDON" | | | |
| 141 | 201699.00 | 1341328.28 | 58.24 61.45 | SSN, 60D NAIL W/WHISKER 10.5' W OF E. FFW ALONG TRAIL | | | |
| 143 | 201998.39 | 1341901.06 | 60.52 | +/- 60' N OF N. FEA @ TRAIL INTX W/62ND AVE. SSN, 60D NAIL W/WHISKERS. 3' W OF E. FFW ALONG TRAIL | | | |
| 144 | 201998.39 | 1340917.08 | 61.09 | SSNT, SET MAG NAIL & "G&O CONTROL" TAG AT NE COR OF INTX OF TRAIL. W OF BRIDGE, 7' SW OF W'LY POST OF BEN | | | |
| 148 | 201670.36 | 1342170.40 | 62.53 | SSHT, SET HUB & MAG NAIL ON N. SIDE OF SE 62ND ST. E OF TRAIL 0.7' NE OF SIGN (LEFT LANE MUST TURN LEFT) | | | |
| 149 | 202251.01 | 1341547.87 | 58.043 | SSS, SET MAG NAIL IN MOST N. SIDE OF NORTHERN D/WAY PICKERING SUBSTATION NEXT TO PRECISION COLLISION. IN SE WHERE ASPHALT MEETS BACK OF WALK. | | | |
| 151 | 203295.57 | 1341677.30 | 55.78 | SFNT, "PACE" TAG & NAIL. 0.9' W. OF E. BACK OF WALK OF LAKE SAMMAMISH PARKWAY. IN FRONT OF BARTELLS. +/- 7. SW FROM LIGHT POLE. | | | |
| 152 | 203650.88 | 1341203.42 | 55.45 | SSN, MAG NAIL IN TOP BACK OF CURB ALONG S. SIDE OF S 56TH ST. 13.5' E. OF E. SIDE ENTRANCE TO CHEVRON/BROW BEAR. 6.5' SW FROM DCB. | | | |
| 153 | 202840.64 | 1341670.30 | 58.21 | SSNT, 1' E. OF W. EDGE OF ASPHALT ALONG TRAIL. +/- 28 S. OF EXTENDED CENTERLINE OF BLACK NUGGET RD. +/- 4 N-NW FROM 14" BIRCH TREE. | | | |
| 154 | 202442.81 | 1341872.70 | 64.59 | SSNT, 3' E. OF W. EDGE OF ASPHALT. 4.5' NE FROM END C | | | |
| 155 | 202308.56 | 1341808.61 | 59.75 | SSNT, 1' E. OF W. EDGE OF ASPHALT ALONG TRAIL. +/- 50 S. OF S. PROP/FENCE LINE TO PRECISION COLLISION. | | | |
| 156 | 201637.26 | 1342174.80 | 61.70 | SSRC, 4' S. OF S. EDGE OF ASPHALT. ALONG 62ND. | | | |
| 157 | 201664.50 | 1341989.77 | 61.78 | SSNT, 5' S. OF E'LY BOLLARD @ END OF TRAIL. N. SIDE OF 62ND ST. 4.5' W. OF E'LY END OF WOOD FENCE. | | | |
| 158 | 202112.56 | 1341958.97 | 61.96 | SSN, PK NAIL $\pm/-$ 15' S. OF KEYPAD INSIDE STORAGE FACILITY. 0.5' E. OF W. EDGE OF ASPHALT IN FRONT OF BAY $\#507$. | | | |
| 159 | 201851.57 | 1342008.73 | 62.11 | SSN, 1' W. OF E. EDGE OF ASPHALT. +/- 7' NW FROM W. END OF CHAIN LINK FENCE AND GATE POST. | | | |
| 160 | 201916.16 | 1342115.48 | 63.49 | SSN | | | |
| 161 | 202919.01 | 1341941.65 | 62.04 | SSNT, E. SIDE OF BLACK NUGGET RD. 17.5' S-SW OF 25MP | | | |

RIGHT-OF-WAY DISCLAIMER

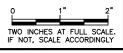THE RIGHT-OF-WAY AND/OR PROPERTY LINES SHOWN HEREON ARE BASED ON AVAILABLE INFORMATION, NOT ON A SURVEYED LOCATION AND ARE ONLY APPROXIMATE.





SCALE: NI DRAWN: A CHECKED:

PRELIMINARY NOT FOR CONSTRUCTION





ISSAQUAH WASHINGTON ОЕ

EAST LAKE SAMMAMISH PARKWAY SE IMPROVEMENTS CITY KING COUNTY

2 SHEET: OF:

XX JOB NO.: 13570 SV_CTRL DWG:

GENERAL NOTES:

- ALL MATERIALS AND WORKMANSHIP SHALL BE FURNISHED AND SUPPLIED IN ACCORDANCE WITH THE 2014 WASHINGTON STATE DEPARTMENT OF TRANSPORTATION STANDARD SPECIFICATIONS FOR ROAD, BRIDGE AND MUNICIPAL CONSTRUCTION AND CITY OF COVINGTON PUBLIC WORKS STANDARDS UNLESS OTHERWISE SPECIFICALLY NOTED.
- 2. THE CONTRACTOR SHALL BE RESPONSIBLE TO CONTACT AND COORDINATE WITH ALL UTILITY COMPANIES IN ORDER TO ASSURE THAT ALL LINES, PIPES, POLES AND OTHER APPURTENANCES ARE PROPERLY LOCATED, SECURED, AND/OR PROTECTED. BURIED UTILITIES (WHERE KNOWN) ARE SHOWN IN THEIR APPROXIMATE LOCATION. THE CONTRACTOR SHALL HAVE UTILITIES VERIFIED ON THE GROUND PRIOR TO ANY CONSTRUCTION. NOTIFY THE UNDERGROUND UTILITIES LOCATE CENTER: 1–800–424–5555.
- THE CONTRACTOR SHALL HAVE A COPY OF THESE PLANS, ANY ADDENDA, CHANGE ORDERS AND THE CONTRACT SPECIFICATIONS ON THE JOB SITE WHENEVER CONSTRUCTION IS IN PROGRESS.
- THE CONTRACTOR SHALL PROMPTLY NOTIFY THE ENGINEER IN THE EVENT OR DISCOVERY OF UNSUITABLE SOILS OR HIGH GROUND WATER CONDITIONS OR DISCREPANCIES FROM THE PLANS.
- WHEREVER PLANS REFER TO "SAWCUT" OF ASPHALT CONCRETE PAVEMENT OR OIL MAT, OR CONCRETE SURFACE, THE CONTRACTOR SHALL PERFORM A "NEAT LINE CUT" PER SPECIFICATIONS.
- 6. CATCH BASINS AND CURB INLETS AT FLOWLINES HAVE BEEN SHOWN IN GENERAL WITH A RELATIVE STATION AND OFFSET. THE INTENT OF THIS PROJECT IS TO LOCATE THE CATCH BASINS AND CURB INLETS IN THE FLOWLINE AT THEIR RESPECTIVE ELEVATIONS.
- 7. THE CONTRACTOR SHALL MAINTAIN A CLEAN LEGIBLE SET OF RECORD DRAWINGS AND PROVIDE A SET TO THE OWNER PRIOR TO DEMOBILIZATION OF THE SITE. SEE SPECIFICATIONS.

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|-----------|--------------|-----------|------------|--------------------------|-------------------|--------|---------|--------|----------------|
| ANGLE PT. | P.I. STATION | NORTHING | EASTING | DISTANCE P.I. TO P.I. | BEARING | RADIUS | TANGENT | LENGTH | DELTA |
| PI1 | 0+00.00 | 200881.86 | 1343116.87 | | | | | | |
| | | | | 1904.96 | N 38° 11' 35" W | | | | |
| PC2 | 19+04.96 | 202379.02 | 1341939.01 | | | | | | |
| PI2 | | 202821.92 | 1342502.01 | | | 716.34 | 147.24 | 290.44 | 23' 13' 49.00" |
| PT2 | 21+95.40 | 202636.99 | 1341809.95 | | | | | | |
| | | | | 1078.51 | N 26° 34' 40.5" W | | | | |
| PI3 | 32+73.91 | 203678.94 | 1341531.49 | | | | | | |
| | | | | 126.07 | N 14° 57' 46" W | | | | |
| PI4 | 34+00.00 | 203800.75 | 1341498.94 | | | | | | |

| | SE 62ND STREET CONSTRUCTION CENTERLINE ALIGNMENT TABLE | | | | | | | | | | | |
|-----------|--|-----------|------------|--------------------------|-------------------|---------|---------|--------|----------------|--|--|--|
| ANGLE PT. | P.I. STATION | NORTHING | EASTING | DISTANCE P.I. TO P.I. | BEARING | RADIUS | TANGENT | LENGTH | DELTA | | | |
| PI1 | 120+50.00 | 201650.81 | 1342033.67 | | | | | | | | | |
| | | | | 158.33 | N 88° 50' 50.9" W | | | | | | | |
| PC2 | 122+08.33 | 201653.99 | 1342191.98 | | | | | | | | | |
| PI2 | | 200279.27 | 1342219.63 | | | 1375.00 | 63.08 | 126.07 | 05° 15' 11.09" | | | |
| PRC | 123+34.40 | 201650.75 | 1342317.96 | 126.01 | S 88° 31' 33.5" W | | | | | | | |
| PI3 | | 201830.29 | 1342330.83 | | | 180.00 | 69.63 | 132.87 | 42* 17' 38.37" | | | |
| PT3 | 124+67.27 | 201688.82 | 1342442.12 | | | | | | | | | |
| | | | | 149.68 | N 72° 57' 12.8" W | | | | | | | |
| P4 | 126+16.95 | 201781.37 | 1342559.76 | | | | | | | | | |



| SCALE: NOTED | DRAWN: A.A.J. | CHECKED: C.B.W. | APPROVED: B.L.S. |
|--------------|---------------|-----------------|------------------|
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| | DATE | |
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| PRELIMINARY NOT FOR CONSTRUCTION | REVISION | |
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ISSAQUAH

WASHINGTON
ISH PARKWAY SE

EAST LAKE SAMMAMISH PARKWAY SE IMPROVEMENTS

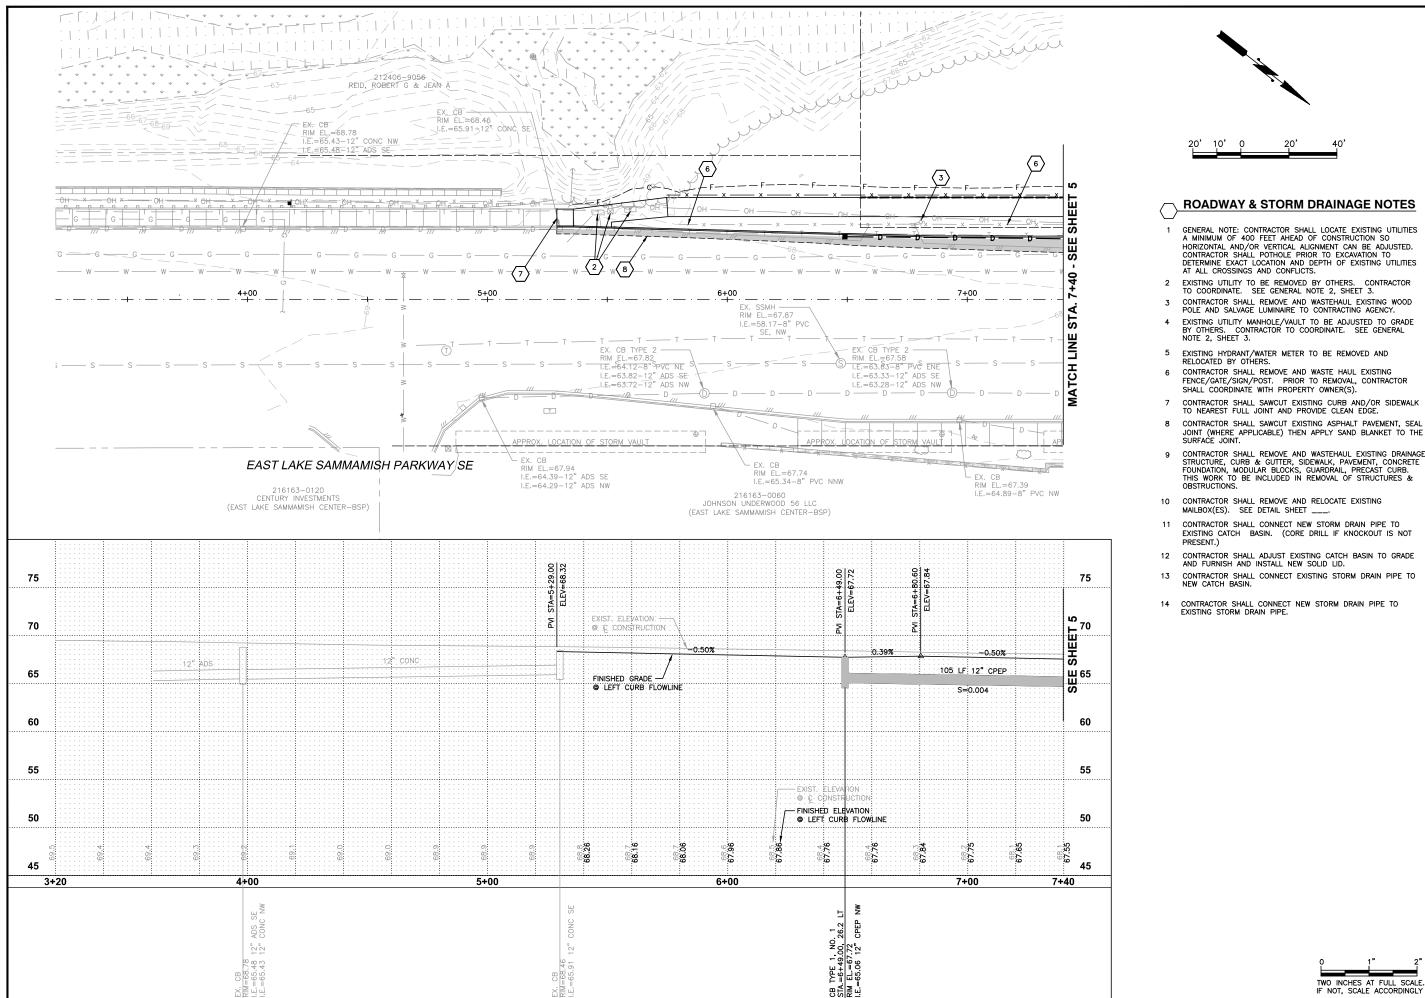
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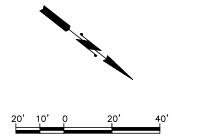
SHEET: 3

OF: XX

JOB NO.: 13570

DWG: ALIGNMENT





- GENERAL NOTE: CONTRACTOR SHALL LOCATE EXISTING UTILITIES A MINIMUM OF 400 FEET AHEAD OF CONSTRUCTION SO HORIZONTAL AND/OR VERTICAL ALICAMENT CAN BE ADJUSTED. CONTRACTOR SHALL POTHOLE PRIOR TO EXCAVATION TO DETERMINE EXACT LOCATION AND DEPTH OF EXISTING UTILITIES AT ALL CROSSINGS AND CONFLICTS.
- 2 EXISTING UTILITY TO BE REMOVED BY OTHERS. CONTRACTOR TO COORDINATE. SEE GENERAL NOTE 2, SHEET 3.
- CONTRACTOR SHALL REMOVE AND WASTEHAUL EXISTING WOOD POLE AND SALVAGE LUMINAIRE TO CONTRACTING AGENCY.
- EXISTING UTILITY MANHOLE/VAULT TO BE ADJUSTED TO GRADE BY OTHERS. CONTRACTOR TO COORDINATE. SEE GENERAL NOTE 2, SHEET 3.
- 5 EXISTING HYDRANT/WATER METER TO BE REMOVED AND RELOCATED BY OTHERS.
- 6 CONTRACTOR SHALL REMOVE AND WASTE HAUL EXISTING FENCE/GATE/SIGN/POST. PRIOR TO REMOVAL, CONTRACTOR SHALL COORDINATE WITH PROPERTY OWNER(S).
- 7 CONTRACTOR SHALL SAWCUT EXISTING CURB AND/OR SIDEWALK
- TO NEAREST FULL JOINT AND PROVIDE CLEAN EDGE. 8 CONTRACTOR SHALL SAWCUT EXISTING ASPHALT PAVEMENT, SEAL
- CONTRACTOR SHALL REMOVE AND WASTEHAUL EXISTING DRAINAGE STRUCTURE, CURB & GUTTER, SIDEWALK, PAVEMENT, CONCRETE FOUNDATION, MODULAR BLOCKS, GUARDRAIL, PRECAST CURB. THIS WORK TO BE INCLUDED IN REMOVAL OF STRUCTURES & OBSTRUCTIONS.
- 10 CONTRACTOR SHALL REMOVE AND RELOCATE EXISTING MAILBOX(ES). SEE DETAIL SHEET ____.
- CONTRACTOR SHALL CONNECT NEW STORM DRAIN PIPE TO EXISTING CATCH BASIN. (CORE DRILL IF KNOCKOUT IS NOT
- 12 CONTRACTOR SHALL ADJUST EXISTING CATCH BASIN TO GRADE AND FURNISH AND INSTALL NEW SOLID LID.
- 13 CONTRACTOR SHALL CONNECT EXISTING STORM DRAIN PIPE TO NEW CATCH BASIN.
- 14 CONTRACTOR SHALL CONNECT NEW STORM DRAIN PIPE TO EXISTING STORM DRAIN PIPE.



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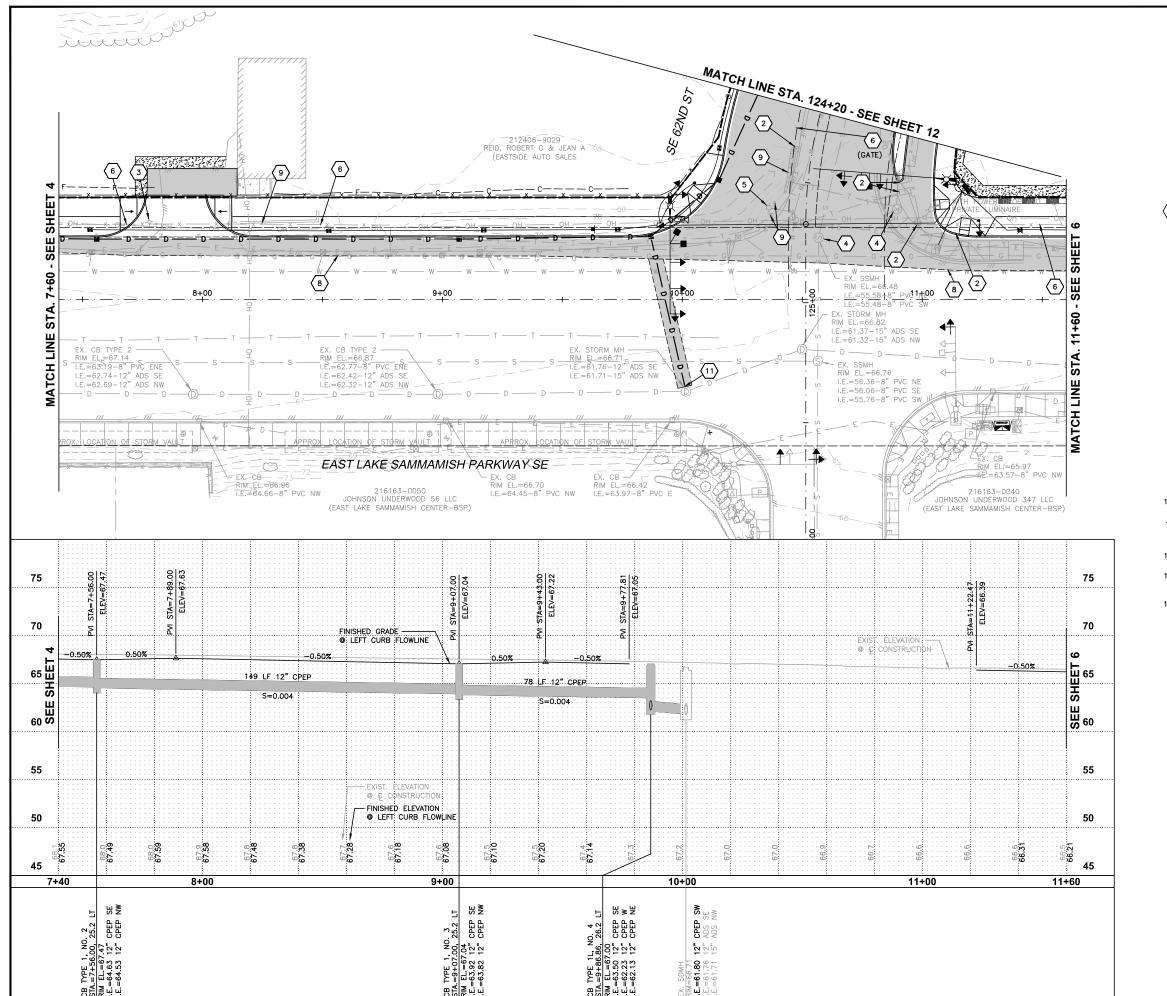
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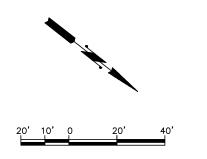
SAMMAMISH PARKWAY PROFILE TO 7+40 PLAN AND STA. 3+20 LAKE CITY NG COUNTY

SHEET: XX OF: JOB NO.: 13570

FLSP PP

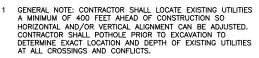
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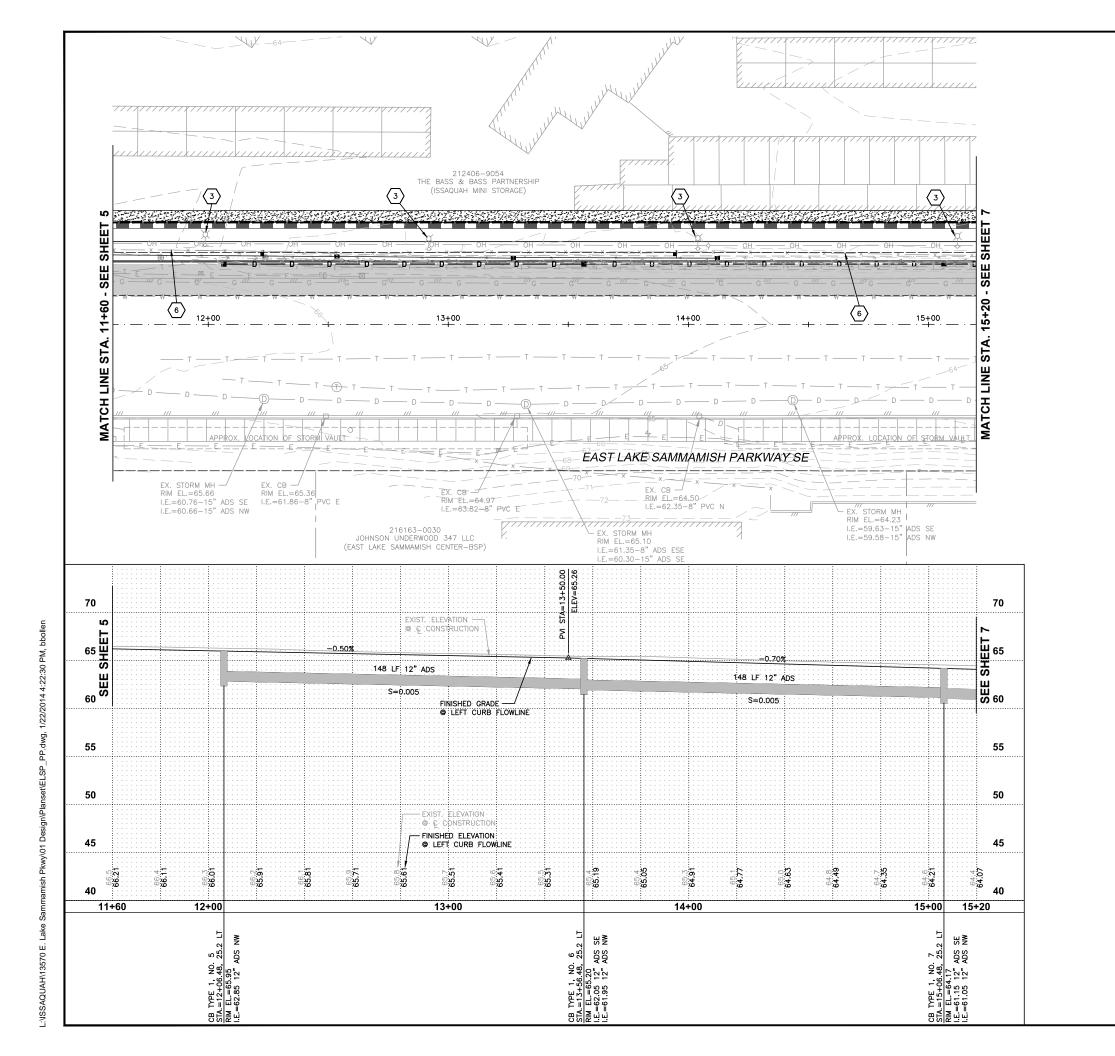
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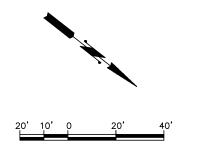
SAMMAMISH PARKWAY

SE

PLAN AND PROFILE STA. 7+40 TO 11+60 ОЕ EAST LAKE CITY

SHEET: 5 XX OF: JOB NO.: 13570 DWG. FLSP PP

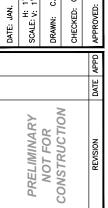




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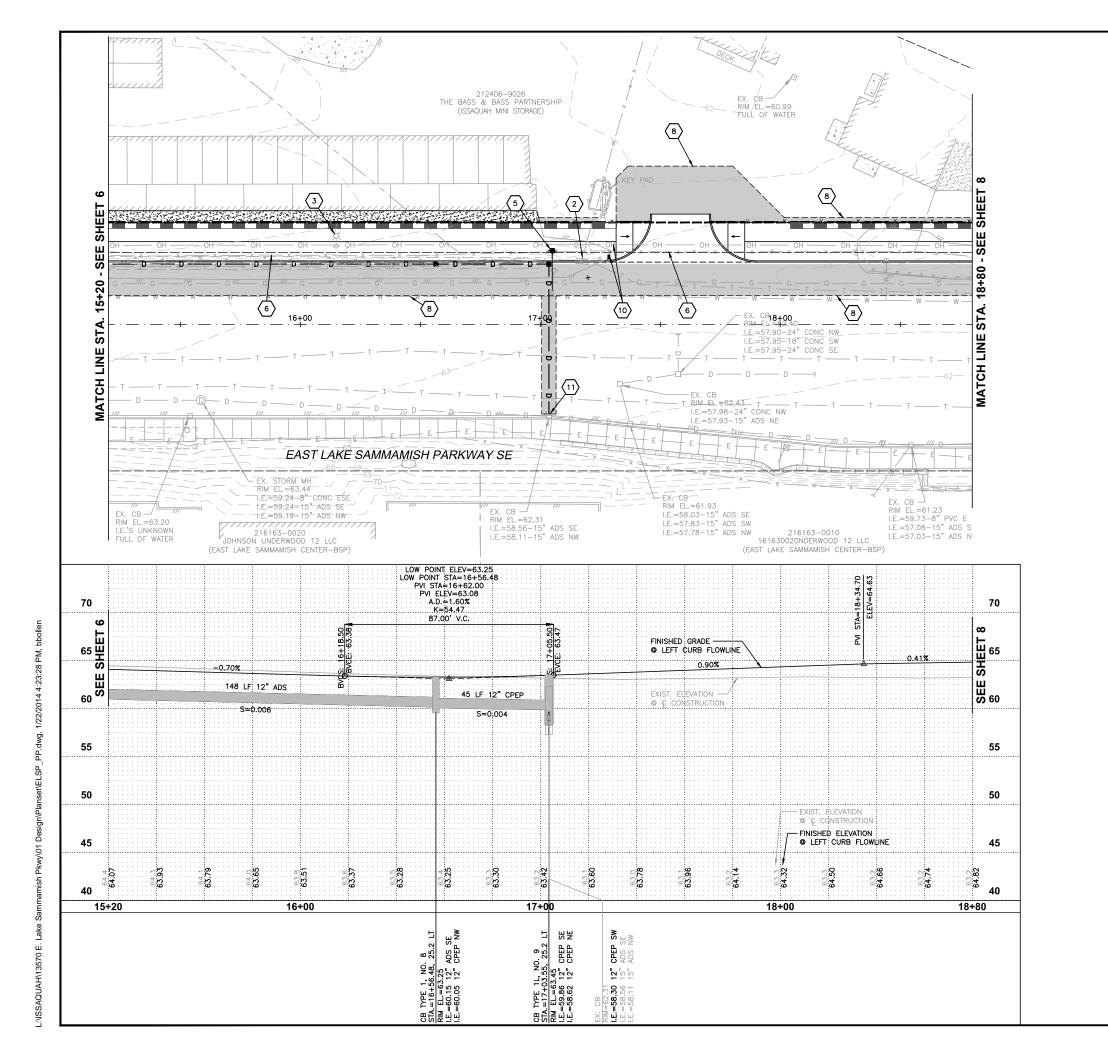
ISSAQUAH WASHINGTO


SAMMAMISH PARKWAY PROFILE TO 15+20

PLAN AND STA. 11+60 7 Ы EAST LAKE CITY

SE COUNT

| SHEET: | 6 |
|----------|---------|
| OF: | XX |
| JOB NO.: | 13570 |
| DWG: | ELSP_PP |



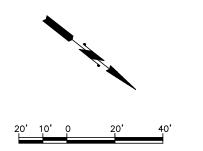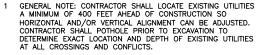


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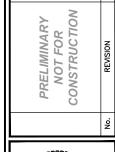
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SCALE: V: 1

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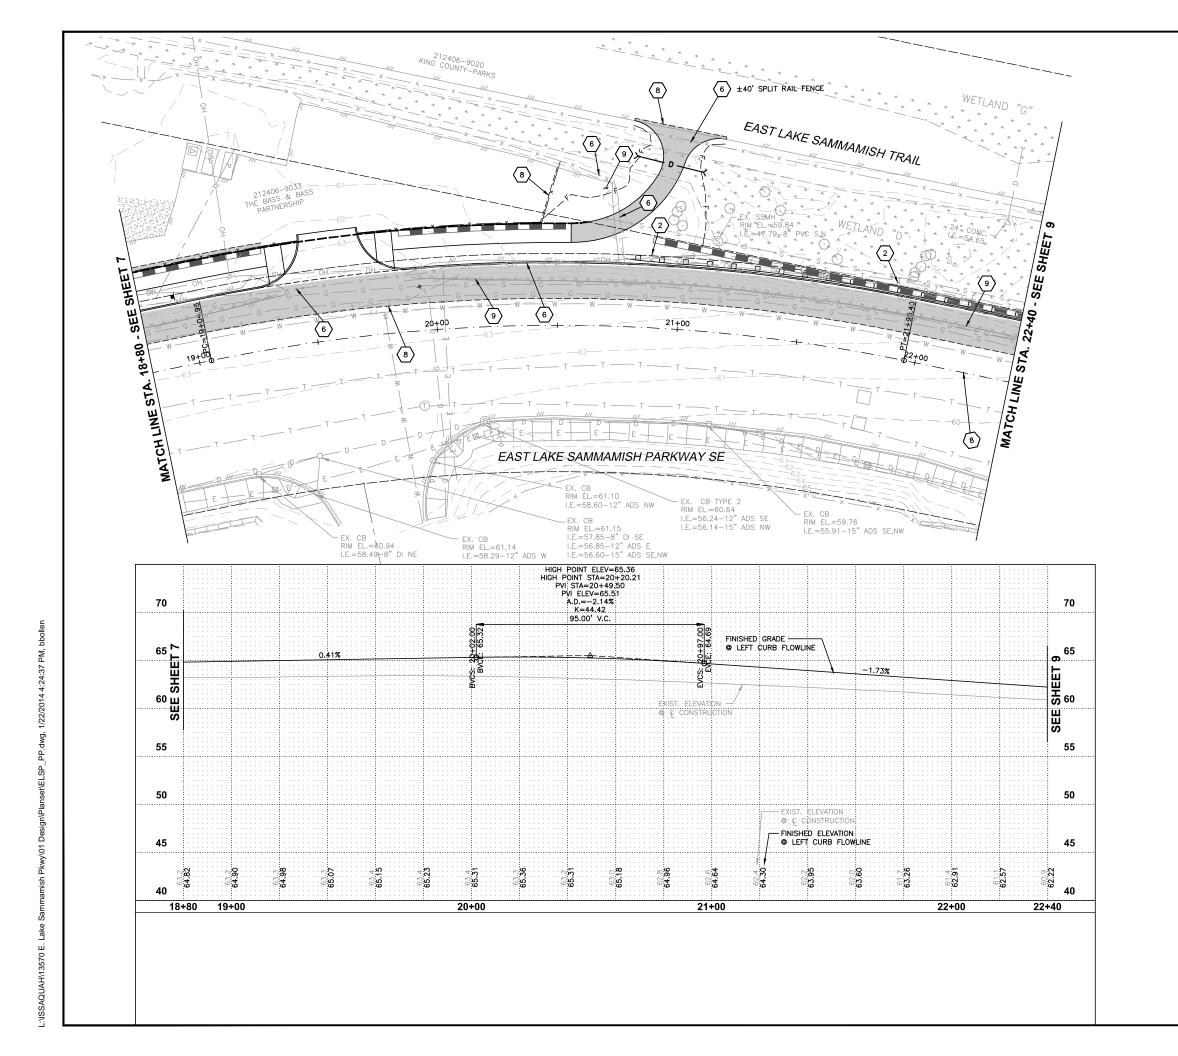
SAMMAMISH PARKWAY


PROFILE TO 18+80

PLAN AND | STA. 15+20 |


OF EAST LAKE CITY VG COUNTY

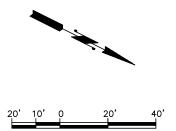SHEET: XX OF: JOB NO.: 13570 DWG. FLSP PP





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DATE: JAN.
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SCALE: V: 1

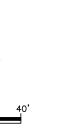PRELIMINARY NOT FOR CONSTRUCTION





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PROFILE TO 22+40

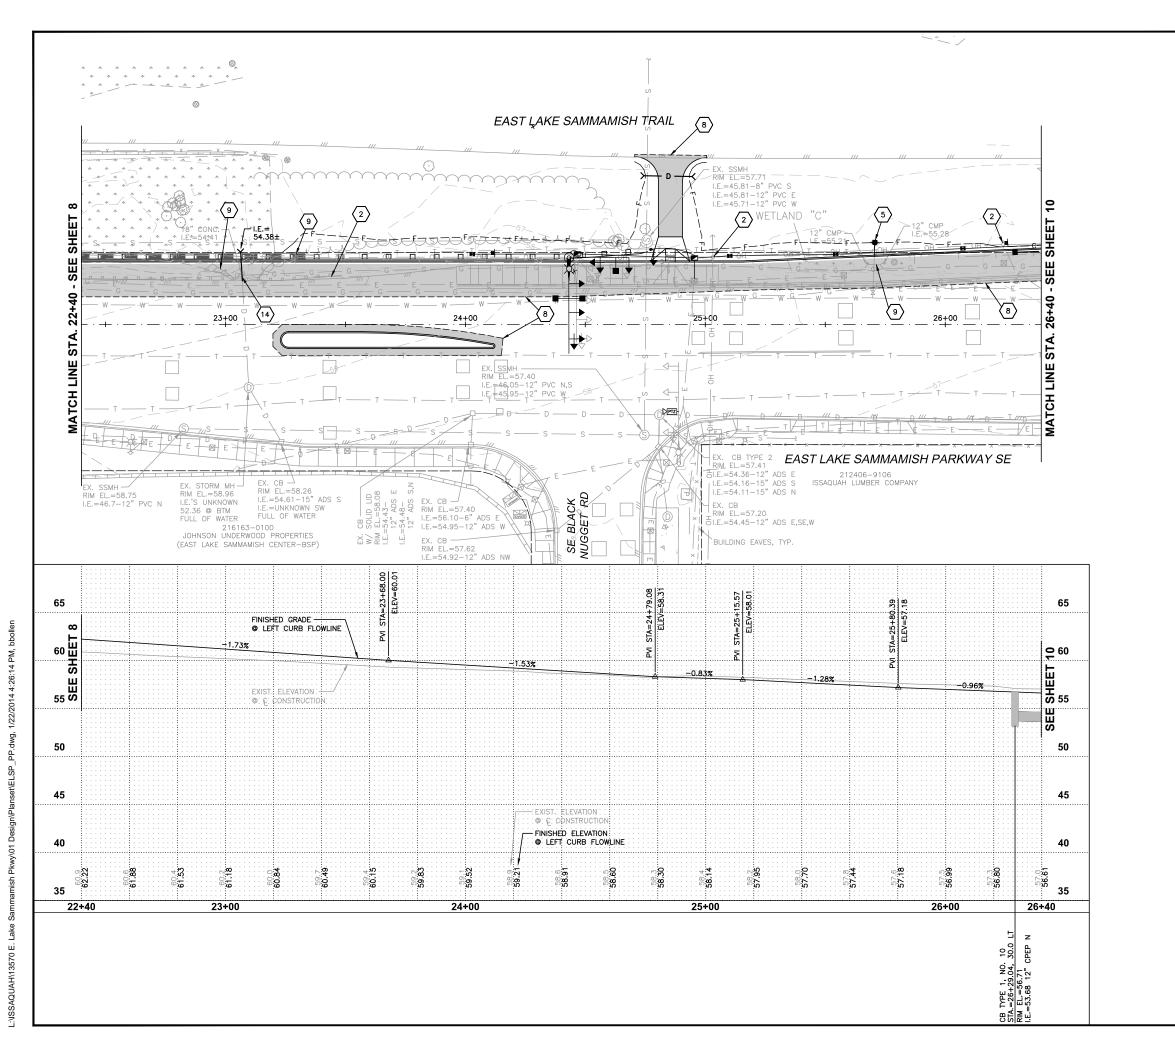
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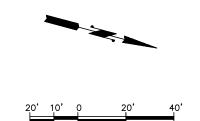
ISSAQUAH WASHINGTO

OF

SAMMAMISH PARKWAY EAST LAKE CITY VG COUNTY

SHEET: XX OF: JOB NO.: 13570 DWG. FLSP PP





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SCALE: V: 1

PRELIMINARY NOT FOR CONSTRUCTION





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ISSAQUAH WASHINGTO

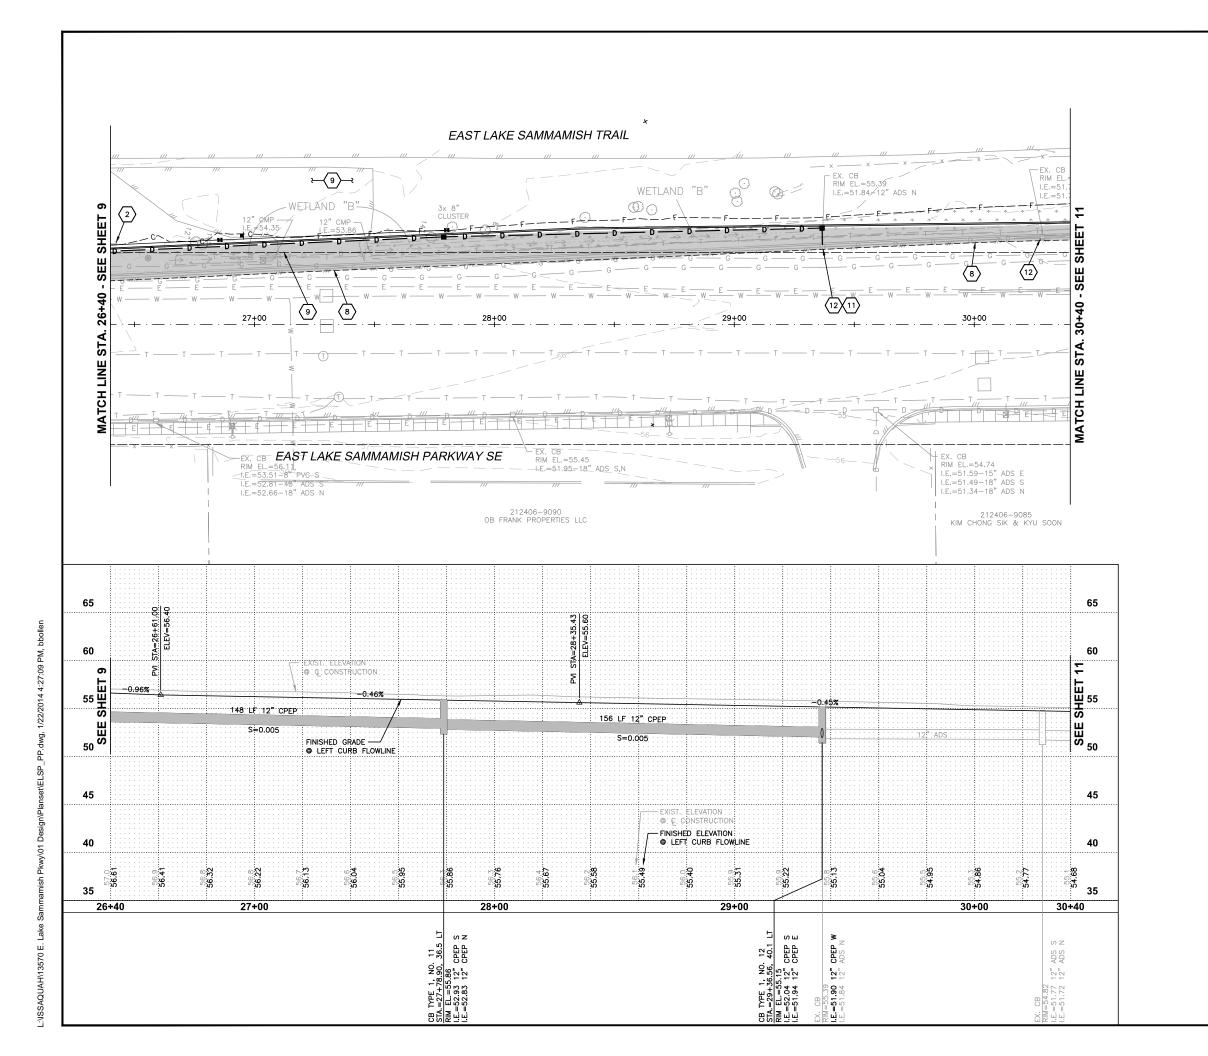
SAMMAMISH PARKWAY OF EAST LAKE CITY VG COUNTY

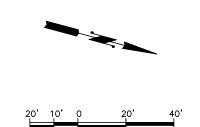
PLAN AND PROFILE STA. 22+40 TO 26+4

SHEET: 9 XX OF: JOB NO.: 13570

FLSP PP

DWG.





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DATE: JAN.

SCALE: V: 1



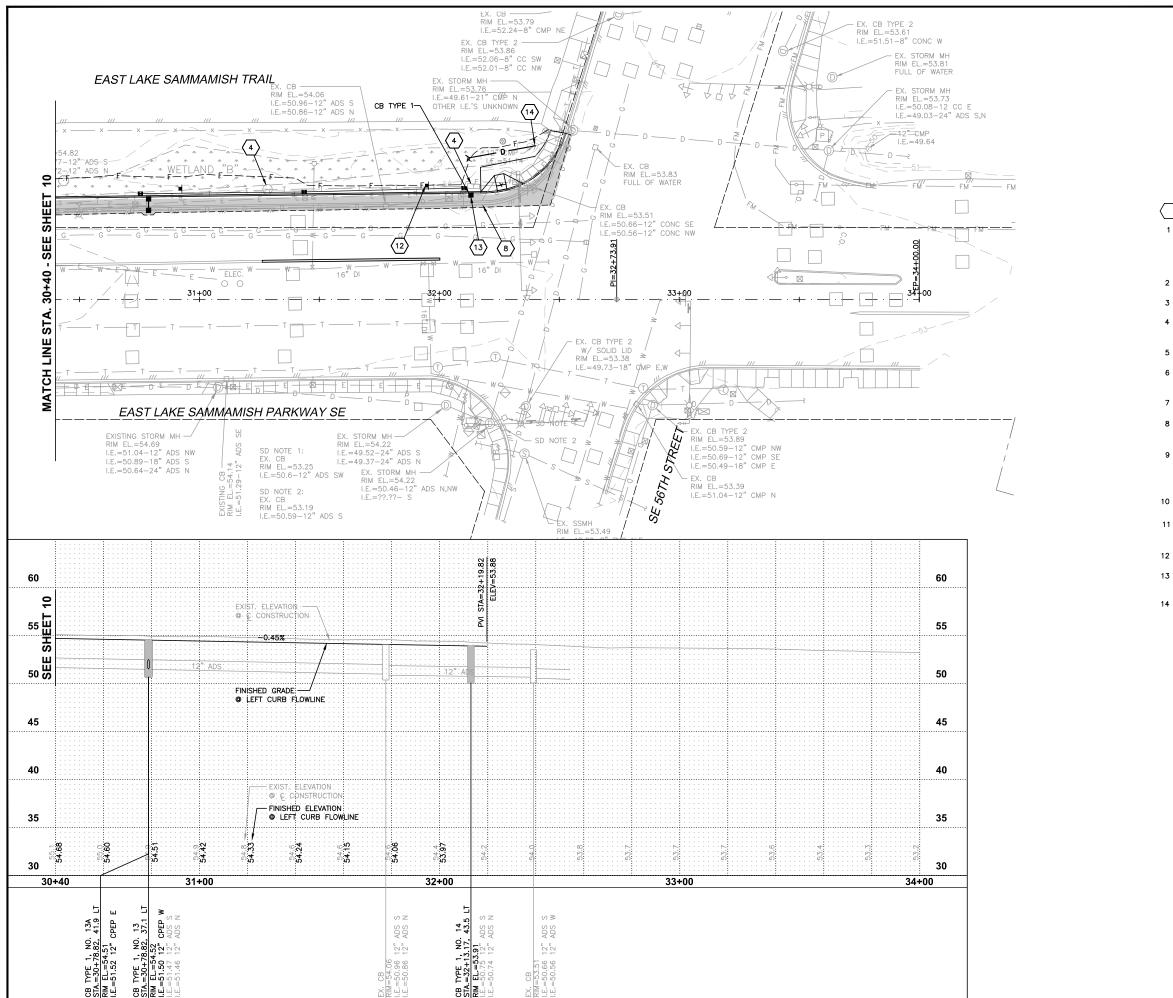
ISSAQUAH WASHINGTO

SAMMAMISH PARKWAY SE IMPROVEMENTS

PLAN AND PROFILE STA. 26+40 TO 30+4

OF EAST LAKE CITY

10 SHEET: XX JOB NO.: 13570 DWG. FLSP PP





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| DATE: JAN. 2014 SCALE: V.: 1"=5' DRAWN: C.B.W. CHECKED: C.B.W. APPROVED: B.L.S. |
|---|
| |

PRELIMINARY NOT FOR CONSTRUCTION





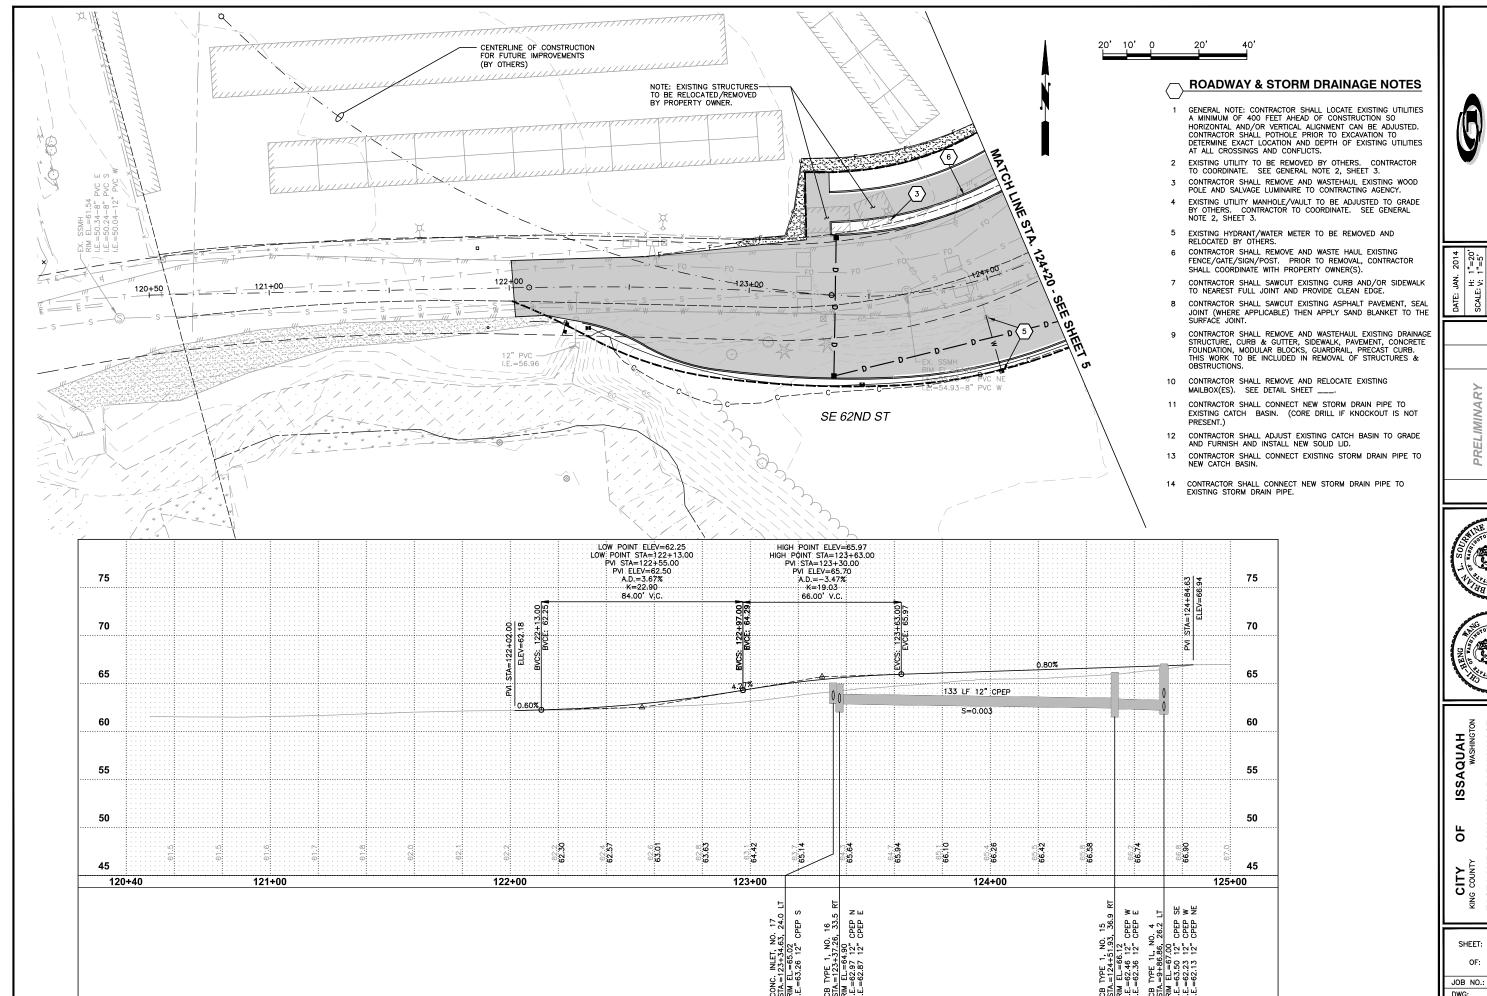
SE ISSAQUAH WASHINGTO

SAMMAMISH PARKWAY OF EAST LAKE CITY NG COUNTY

PLAN AND PROFILE STA. 30+40 TO 34+00

11 XX

SHEET: OF: TWO INCHES AT FULL SCALE.
IF NOT, SCALE ACCORDINGLY JOB NO.: 13570 DWG: FLSP PP





PRELIMINARY NOT FOR CONSTRUCTION

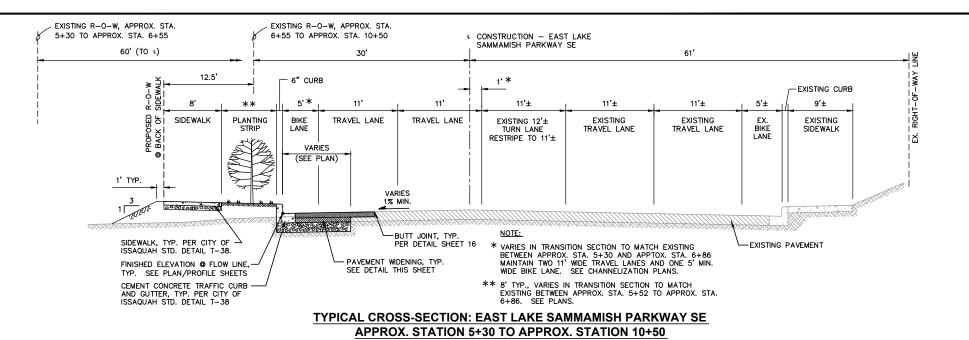


SE

SAMMAMISH PARKWAY S LAKE EAST

AND

12 SHEET: XX OF: JOB NO.: 13570 62ND PP




- FINISHED GRADE, TYP. 1 2

NEW PAVEMENT ROADWAY/PAVEMENT WIDENING

1 3" COMPACTED DEPTH HMA CLASS 1/2".

4

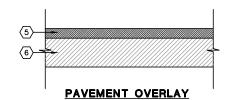
- 2 4" COMPACTED DEPTH ASPHALT TREATED BASE
- $\overline{\langle 3 \rangle}$ 9" COMPACTED DEPTH CRUSHED SURFACING BASE COURSE
- 4 SUITABLE NATIVE, AND/OR GRAVEL BORROW




- (5) MIN. 3" COMPACTED DEPTH HMA CLASS 1/2" (PRELEVEL AS REQUIRED).
- 6 EXISTING ROAD PAVEMENT.


TYPICAL PAVEMENT SECTIONS

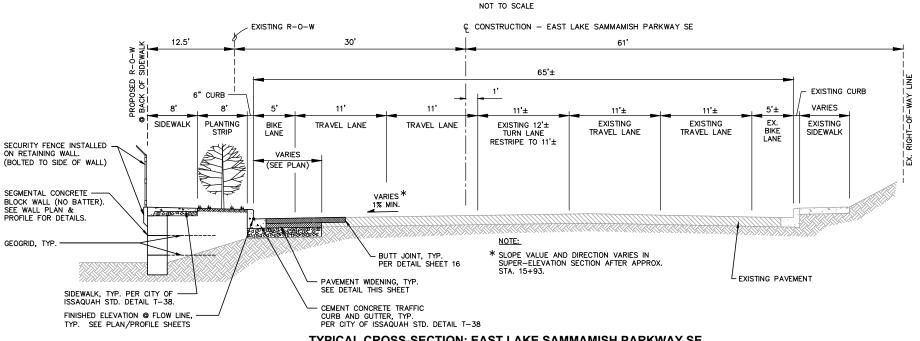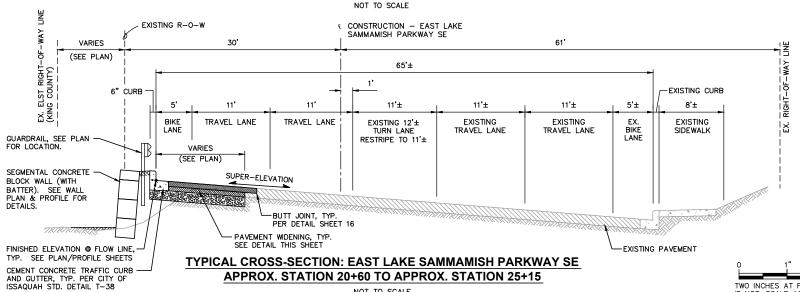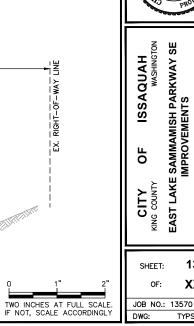NOT TO SCALE









SCALE: DRAWN:

PRELIMINARY NOT FOR CONSTRUCTION

NO7

SAMMAMISH PARKWAY S MPROVEMENTS

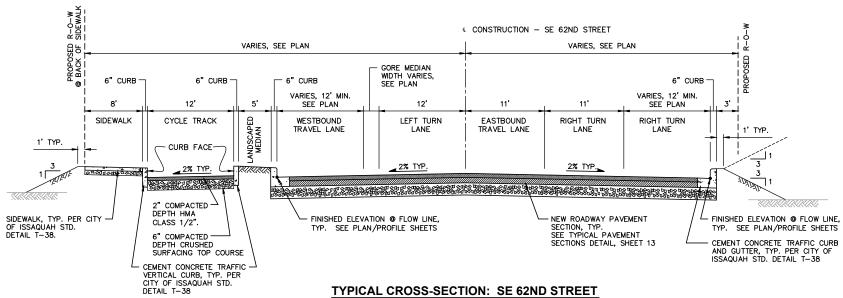
EAST LAKE

13

XX

OF

SHEET:



TYPICAL CROSS-SECTION: SE 62ND STREET APPROX. STATION 123+34 TO APPROX. STATION 124+50

NOT TO SCALE





NOTED SCALE: DRAWN:

PRELIMINARY NOT FOR CONSTRUCTION



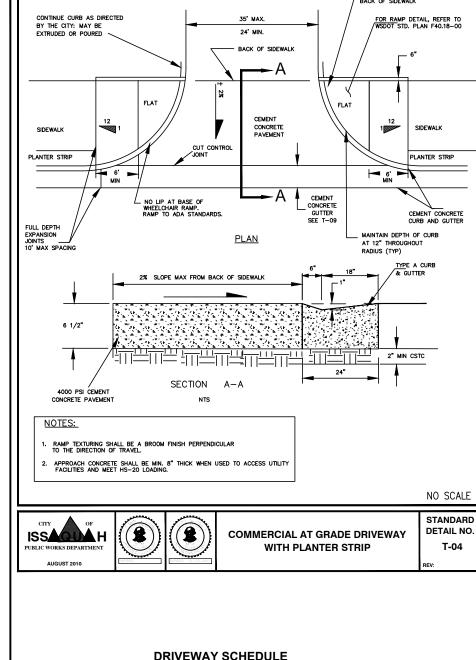


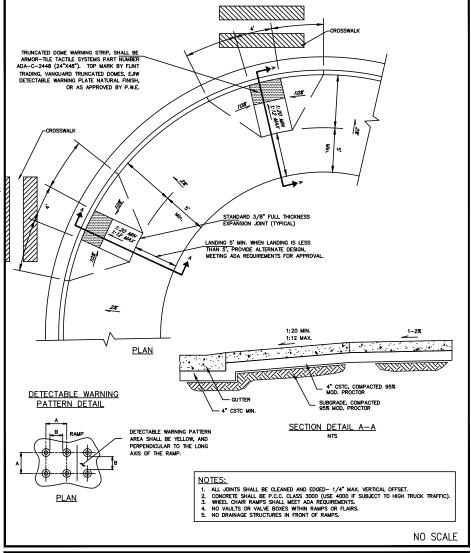
ISSAQUAH WASHINGTON

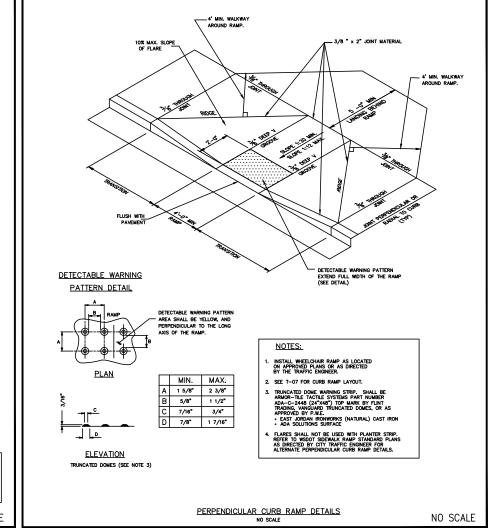
SAMMAMISH PARKWAY SE IMPROVEMENTS ОЕ

EAST LAKE CITY NG COUNTY

14 SHEET: XX OF: JOB NO.: 13570 TYPSEC











PERPENDICULAR CURB RAMP (1 OF 2) STANDARD DETAIL NO. T-07








PERPENDICULAR CURB RAMP (2 OF 2) **STANDARD** DETAIL NO. T-08

DRIVEWAY SCHEDULE


| | CONC | RETE DRIV | DRIVEWAY REPAIR (BEYOND APPROACH) | | | | | | |
|-------------------------|---------------|-----------|--------------------------------------|------------|--------------|--------------|-----------------|----------|--------------|
| STREET | DRIVEWAY # | STATION | SIDE | "A" (TYPE) | AREA (SY) | RAMP LEFT | LENGTH RIGHT | MATERIAL | AREA (SY) |
| | | | | | | | | | |
| | | | | | | | | | |
| FACT LAWE | | | | | | | | | |
| EAST LAKE SAMMAMMISH | | | | | | | | | |
| PARKWAY | | | | | | | | | |
| | | | | | | | | | |
| | | | | | | | | | |
| | | | | | | | | | |
| | | | | | | | | | |

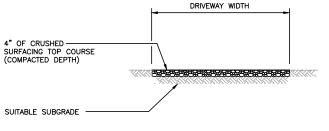NOTE: CONTRACTOR SHALL CONFIRM ALL DRIVEWAY APPROACH STATIONS AND WIDTHS WITH CONTRACTING AGENCY PRIOR TO INSTALLATION.




CRUSHED ROCK DRIVEWAY REPAIR

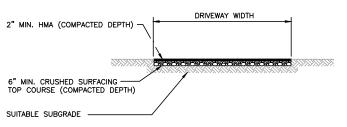NOT TO SCALE



HMA DRIVEWAY REPAIR

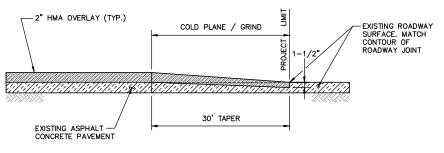NOT TO SCALE



NOTE: PROVIDE TRANSITION TAPERS AT PROJECT TERMINATION LIMITS.

OVERLAY TRANSITION TAPER DETAIL AT PROJECT LIMITS

NOT TO SCALE

15 SHEET: XX OF: JOB NO.: 13570

ROAD DET1

DWG:

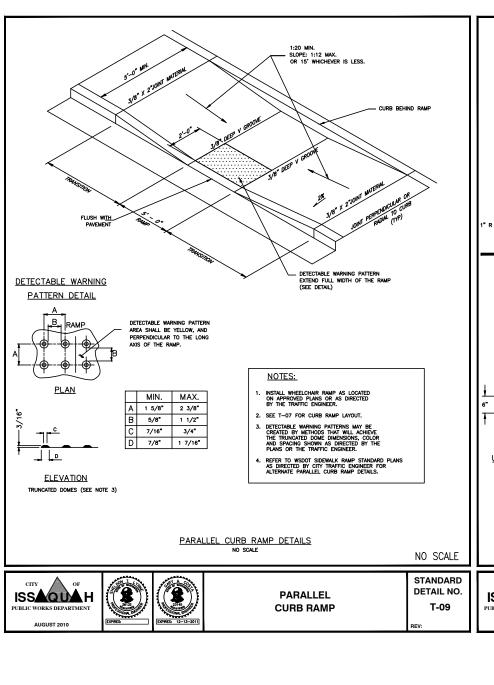
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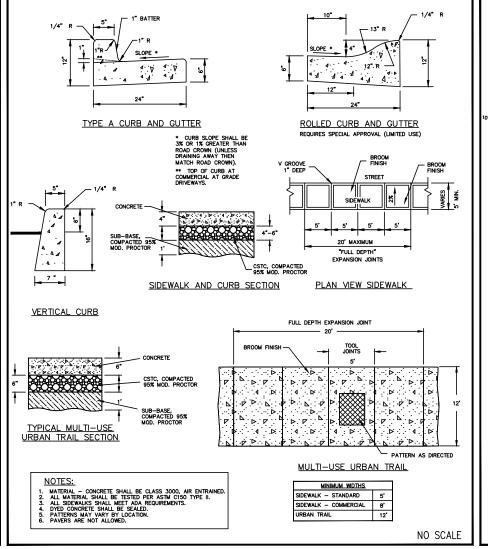
PRELIMINARY NOT FOR CONSTRUCTION


SAMMAMISH PARKWAY SE IMPROVEMENTS ISSAQUAH WASHINGTO LAKE


CITY EAST I

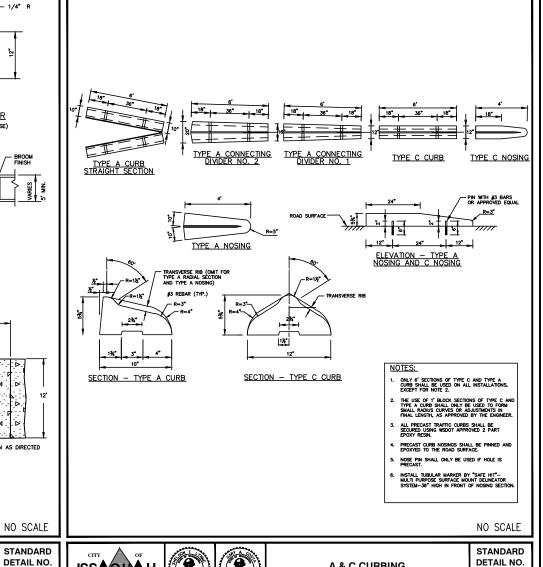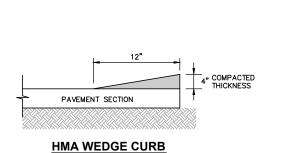OF












NOT TO SCALE

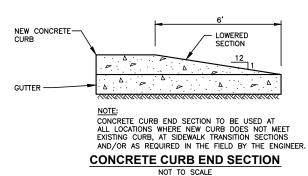

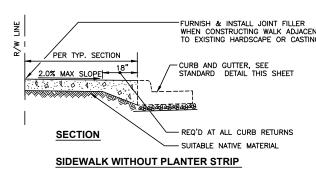

SIDEWALKS/CURBS/URBAN TRAILS

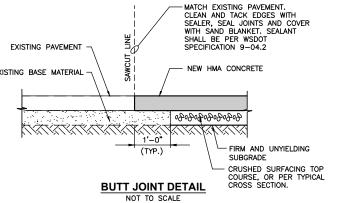

A & C CURBING

FURNISH & INSTALL JOINT FILLER WHEN CONSTRUCTING WALK ADJACENT TO EXISTING HARDSCAPE OR CASTINGS EXISTING BASE MATERIAL -

ISSAQUA H

T-38

ISSAQUAH WASHINGTO SAMMAMISH PARKWAY ROADWAY DETAILS OF LAKE CITY EAST

SE

CHECKED:

DRAWN:

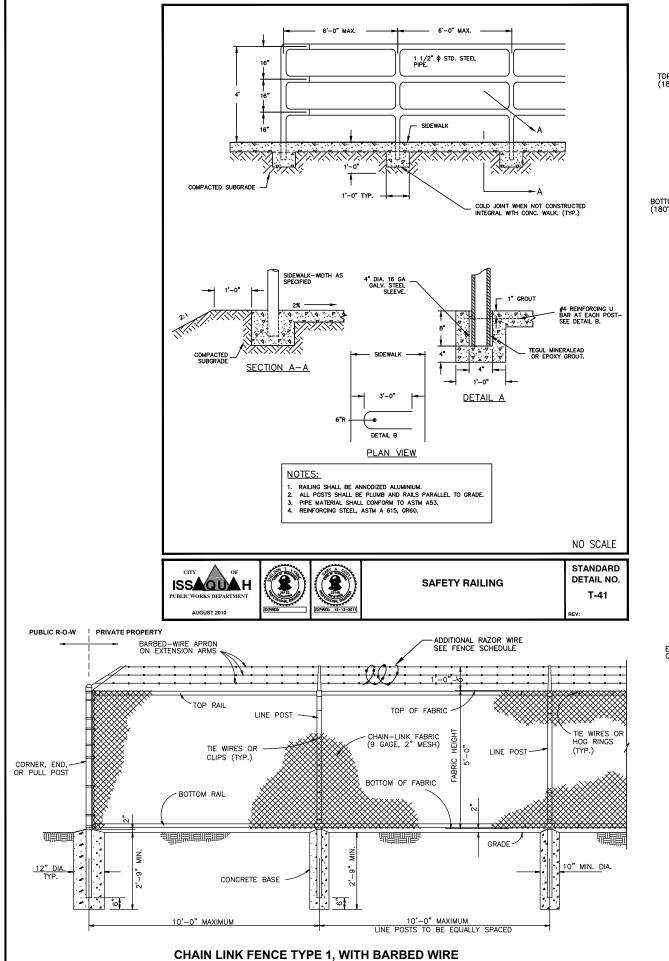
PRELIMINARY NOT FOR CONSTRUCTION

T-39


16 SHEET: XX OF: JOB NO.: 13570

ROAD DFT2

DWG:



NOT TO SCALE

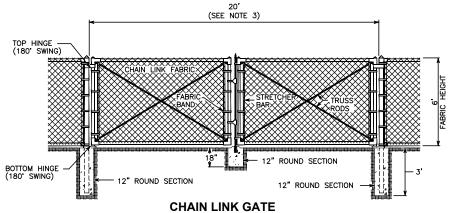


- FENCE FABRIC SHALL BE SECURED TO GATE FRAMES WITH KNUCKLED SELVAGE ALONG TOP EDGE FOR TYPE 6 CHAIN LINK FENCE INSTALLATIONS.
- 2. MINIMUM POST LENGTH: 8'-8"

NOTES:

- CONTRACTOR SHALL FIELD VERIFY LOCATION/DIMENSION OF GATE WITH CONTRACTING AGENCY PRIOR TO WORK.
- 4. GATES FOR SECURITY FENCE SHALL HAVE BARBED WIRE AND/OR RAZOR WIRE PER CHAIN LINK SECURITY FENCE DETAIL AND FENCE SCHEDULE.

NOTES

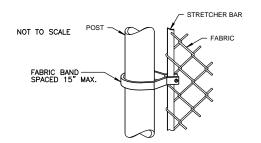- TENSION WIRE SHALL BE PLACED WITHIN THE LIMITS OF THE FIRST FULL FABRIC WEAVE.
- 3. DETAILS ARE ILLUSTRATIVE AND SHALL NOT LIMIT HARDWARE DESIGN OR POST SELECTION OF ANY PARTICULAR FENCE TYPE.




METHOD OF FASTENING STRETCHER BAR TO POST (SHOWN FOR ROUND POST)

FENCE SCHEDULE

| APPROXIMATE LOCATION | ACTION | TYPE | APPROX. LENGTH | | | |
|---|--------|--------------------------------------|--|--|--|--|
| STA. 5+75 TO STA. 10+10 | N | 5' CHAIN LINK FENCE | 440' (INCLUDING A 20' WIDE GATE AT APPROX. STA. 7+89) | | | |
| STA. 123+22 (62ND) TO SAT. 18+60 (ELSP) | N | 5' CHAIN LINK FENCE WITH BARBED WIRE | 863' (INCLUDING A 20' WIDE GATE AT APPROX. STA. 17+58) | | | |
| STA. 18+60 TO STA. 20+51 | N | 5' CHAIN LINK FENCE WITH BARBED WIRE | 219' (INCLUDING A 20' WIDE GATE AT APPROX. STA. 19+59) | | | |

ACTION LEGEND:

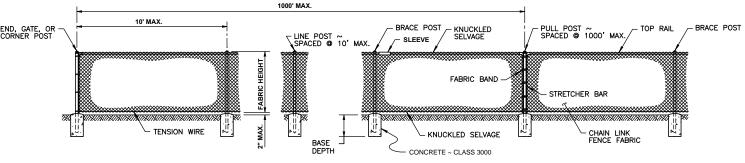- NEW FENCE. CONTRACTOR SHALL FURNISH ALL NECESSARY MATERIAL AND INSTALL NEW FENCE/GATE.
- R: RELOCATE OR REINSTALL EXISTING FENCE.



| POST AN | ID RAIL SPE | CIFICATION | IS | | 3 1/2" | | | |
|---------------------------|------------------------|------------------|-------------------|-------------------|--|--------------|--------------|------------|
| | PIPE | PIPE ROLL FORMED | | H - COLUMN | | 1 5/8" | 1 1/4" | |
| MEMBER | NOM. SIZE (SCH. 40) | SECTION | WEIGHT (lb/ft) | WEIGHT (lb/ft) | | | | 4/1 |
| END, CORNER, OR PULL POST | 2 1/2" DIAM. | A | 5.10 | | £ | 1 7/8. | 1 2 8 | |
| LINE OR BRACE POST | 2" DIAM. | В | 2.40 | 3.26 | <u>+ </u> | FENCE LINE | | 1 5/8" |
| BRACE OR TOP RAIL | 1 1/4" DIAM. | © | 1.35 | | FABRIC LOOP | | | |
| GATE POST | 3 1/2" DIAM. | | | | ~ 2 SIDES (A) | (B) | (c) | H - COLUMN |

CHAIN LINK FENCE HARDWARE

NOT TO SCALE



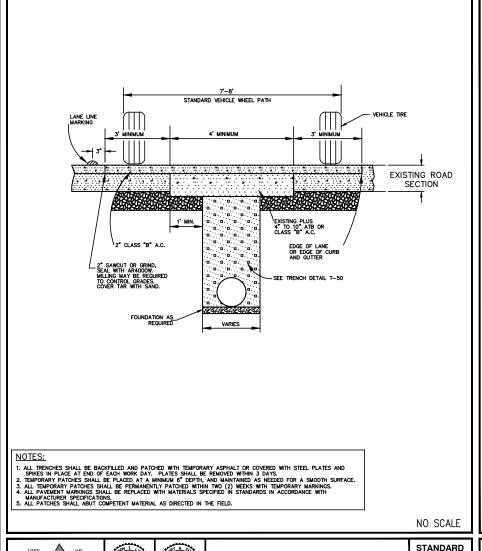
PRELIMINARY NOT FOR CONSTRUCTION

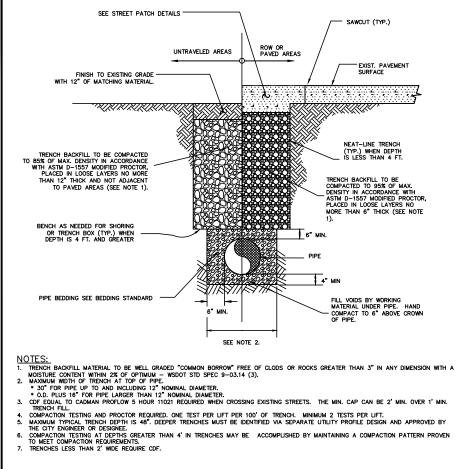




SAMMAMISH PARKWAY SE IMPROVEMENTS ISSAQUAH WASHINGTO OF EAST LAKE CITY

17 SHEET: XX OF: JOB NO.: 13570 DWG: ROAD DET3





NO SCALE





PATCHING FLEXIBLE PAVEMENTS LONGITUDINAL CUTS

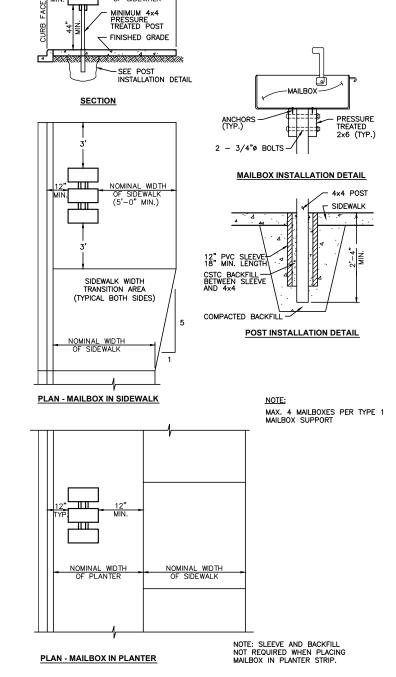
DETAIL NO. ISS QUAH T-49





TRENCH DETAIL

STANDARD DETAIL NO. T-50





NOT TO SCALE



DRAWN:

PRELIMINARY NOT FOR CONSTRUCTION


18 SHEET: XX OF: JOB NO.: 13570 DWG: ROAD DET4


CURB RETURN TABLE

| NUMBER | STATION | OFFSET | ELEV. | DESCRIPTION | CURVE DATA | CUI CENTER | |
|--------|----------|-----------|-------|---------------------|-------------------------------------|----------------------------------|-----------|
| 1 | 9+77.81 | 26.00' LT | | FL CURB AT PC | | | |
| 2 | 10+03.84 | 35.63' LT | | FL CURB AT RAMP TOP | | | |
| 3 | 10+08.09 | 39.86' LT | | FL CURB AT RAMP TOE | D 40.00' | | |
| 4 | 10+10.55 | 43.01' LT | | FL CURB AT RAMP TOE | R=40.00' L=56.78' △081'20'10" | 9+77.81 | 66.00' L1 |
| 5 | 10+13.62 | 48.16' LT | | FL CURB AT RAMP TOP | 2081 20 10 | | |
| 6 | 10+17.36 | 59.98' LT | | FL CURB AT PT | | | |
| 7 | 10+02.17 | 44.47' LT | | FG AT RAMP TOP | | | |
| 8 | 10+04.63 | 47.62' LT | | FG AT RAMP TOP | | | |
| 9 | 9+95.57 | 42.50' LT | | FG AT BACK OF WALK | | | |
| 10 | 10+10.06 | 61.09' LT | | FG AT BACK OF WALK | | | |
| 11 | 11+04.56 | 47.41' LT | | FL CURB AT RAMP TOP | | | |
| 12 | 11+04.68 | 41.41' LT | | FL CURB AT RAMP TOE | | | |
| 13 | 11+04.91 | 37.42' LT | | FL CURB AT RAMP TOE | | | |
| 14) | 11+04.99 | 36.33' LT | | FL CURB AT PCC | | | |
| (15) | 11+07.14 | 30.92' LT | | FL CURB AT RAMP TOP | R=10.00' | 11.14.00 | 37.16' L1 |
| 16 | 11+08.74 | 29.33' LT | | FL CURB AT RAMP TOP | L=11.83° △067*45'42" | L=11.83' 11+14.96 ∆067*45'42" | |
| (17) | 11+11.96 | 27.62' LT | | FL CURB AT PCC | | | |

NOTES:

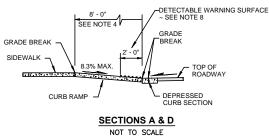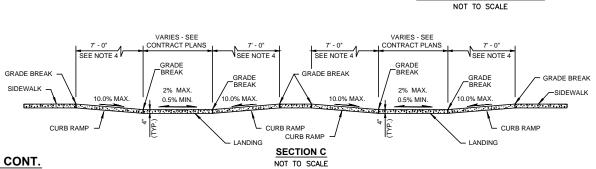
* MATCH EXISTING ELEVATION AT CONNECTION POINT PC = POINT OF CURVATURE PT = POINT OF TANGENCY PRC = POINT OF REVERSE CURVATURE PCC = POINT OF COMPOUND CURVATURE FL = FLOW LINE





CURB RETURN TABLE CONT.

| NUMBER | STATION | OFFSET | ELEV. | DESCRIPTION | CURVE DATA | | RVE POINT |
|--------|----------|-----------|-------|------------------------|-------------------------------------|----------|--------------|
| 18 | 11+15.19 | 26.77' LT | | FL CURB AT RAMP TOE | D 75 001 | | |
| 19 | 11+19.14 | 26.16' LT | - | FL CURB AT RAMP TOE | R=35.00' L=10.69' △017'29'30" | 11+22.47 | 61.00' LT |
| 20 | 11+22.47 | 26.00' LT | | FL CURB AT PT | 2017 23 30 | | |
| 21 | 11+26.13 | 26.00' LT | | FL CURB AT RAMP TOP | | | |
| 22 | 11+11.16 | 41.79' LT | | FG AT RAMP TOP | | | |
| 23 | 11+11.40 | 37.80' LT | | FG AT RAMP TOP | | | |
| 24) | 11+16.32 | 34.12' LT | - | FG AT RAMP TOP | | | |
| 25) | 11+20.27 | 33.52' LT | | FG AT RAMP TOP | | | |
| 26 | 11+13.22 | 53.02' LT | | FG AT BACK OF WALK/PCC | R=10.00' L=16.23' | 11+23.21 | 52.50' LT |
| 27 | 11+23.21 | 42.50' LT | | FG AT BACK OF WALK/PT | L=16.23 Δ092*59′29″ | 11+25.21 | 32.30 L1 |

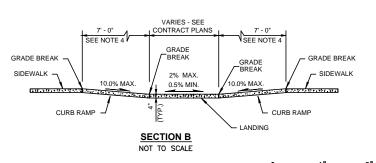

EXPANSION JOINT

NOT TO SCALE

CONTRACTION JOINT

TWO INCHES AT FULL SCALE.
IF NOT, SCALE ACCORDINGLY

DRAWN:

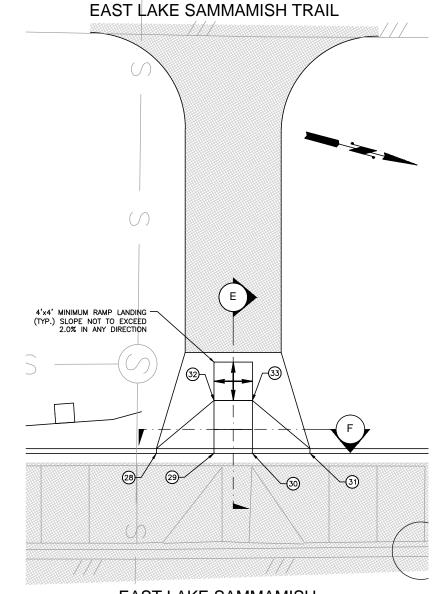
PRELIMINARY NOT FOR CONSTRUCTION

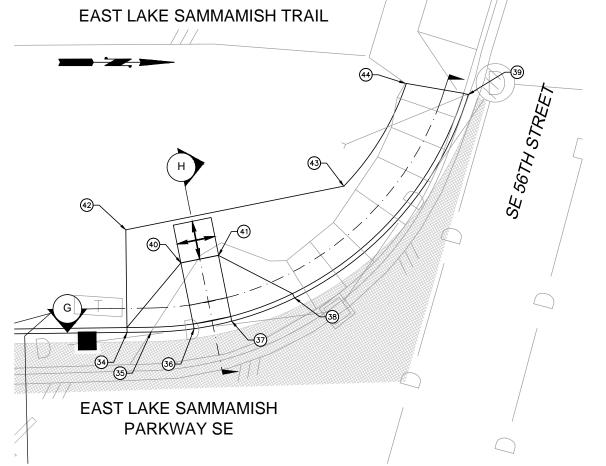




SAMMAMISH PARKWAY SE IMPROVEMENTS ISSAQUAH WASHINGTO О EAST LAKE CITY

19 SHEET: XX JOB NO.: 13570 DWG: INTERSECTION







CURB RAMP NOTES

- WHERE "GRADE BREAK" IS CALLED OUT, THE ENTIRE LENGTH OF THE GRADE BREAK BETWEEN THE TWO ADJACENT SURFACE PLANES SHALL BE FLUSH.
- DO NOT PLACE GRATINGS, JUNCTION BOXES, ACCESS COVERS, OR OTHER APPURTENANCES IN FRONT OF THE CURB RAMP OR ON ANY PART OF THE CURB RAMP OR LANDING.
- 3. SEE CONTRACT PLANS FOR THE CURB DESIGN SPECIFIED. SEE SHEET XX FOR CURB AND GUTTER AND DEPRESSED CURB DETAILS.
- 4. RAMP LENGTH FOR REFERENCE ONLY.
 CONTRACTOR TO FIELD VERIFY AND ADJUST LENGTH
 TO MEET RAMP SLOPE REQUIRENTS PER DETAILS.
 THE CURB RAMP MAXIMUM RUNNING SLOPE SHALL
 NOT REQUIRE THE RAMP LENGTH TO EXCEED 15
- 5. CURB RAMPS AND LANDINGS SHALL RECEIVE BROOM FINISH. SEE STANDARD SPECIFICATIONS 8-14.
- 6. CURB RAMP CROSS SLOPE SHALL NOT EXCEED 2%.
- 7. LANDING CROSS SLOPE SHALL NOT EXCEED 2%.
- 8. DETECTABLE WARNING SURFACE. SEE STANDARD PLAN F-45.10.

CURB RETURN TABLE

| NUMBER | STATION | OFFSET | ELEV. | DESCRIPTION | CURVE DATA | CURVE CENTER POINT | |
|--------|----------|-----------|-------|-------------------------|-------------------------------------|-----------------------|------------|
| 28 | 24+77.43 | 26.00' LT | | FL CURB AT RAMP TOP | | | |
| 29 | 24+83.43 | 26.00' LT | | FL CURB AT RAMP TOE | | | |
| 30 | 24+87.43 | 26.00' LT | | FL CURB AT RAMP TOE | | | |
| 31 | 24+93.43 | 26.00' LT | | FL CURB AT RAMP TOP | | | |
| 32 | 24+83.43 | 31.50' LT | | FG AT RAMP TOP | | | |
| 33 | 24+87.43 | 31.50' LT | | FG AT RAMP TOP | | | |
| 34 | 32+17.32 | 44.42' LT | | FL CURB AT RAMP TOP | | | |
| 35 | 32+19.82 | 44.45' LT | | FL CURB AT PC | | | |
| 36 | 32+24.30 | 44.80' LT | | FL CURB AT RAMP TOE | 25.00, | | |
| 37 | 32+28.22 | 45.58' LT | | FL CURB AT RAMP TOE | R=35.00' L=44.12' △072'13'28" | 32+19.39 | 79.45' LT |
| 38 | 32+34.77 | 48.01' LT | | FL CURB AT RAMP TOP | Δ0/2 13 28 | | |
| 39 | 32+52.84 | 69.18' LT | | FL CURB AT PT/TIE IN * | | | |
| 40 | 32+22.92 | 51.66' LT | | FG AT RAMP TOP | | | |
| 41) | 32+26.85 | 52.45' LT | | FG AT RAMP TOP | | | |
| 42 | 32+17.19 | 55.10' LT | | FG AT BACK OF WALK | | | |
| 43 | 32+39.89 | 70.35' LT | | FG AT BACK OF WALK/PC | R=28.50' | 70.40.70 | 70 45' 1 7 |
| (44) | 32+46.39 | 70.35' LT | | FG AT BACK OF WALK/PT * | L=12.61' △025'21'36" | 32+19.39 | 79.45' LT |

TWO INCHES AT FULL SCALE.
IF NOT, SCALE ACCORDINGLY

PRELIMINARY NOT FOR CONSTRUCTION

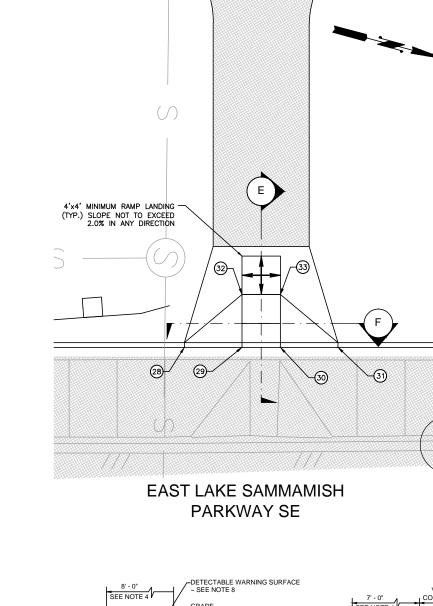
снескер: DRAWN:

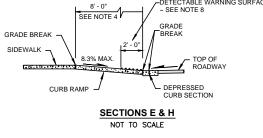


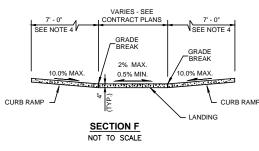


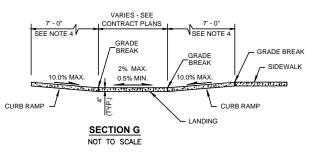
EAST LAKE SAMMAMISH PARKWAY SE IMPROVEMENTS Ы CITY KING COUNTY

20 SHEET: XX OF: JOB NO.: 13570 INTERSECTION










NOTES:

VOIES.

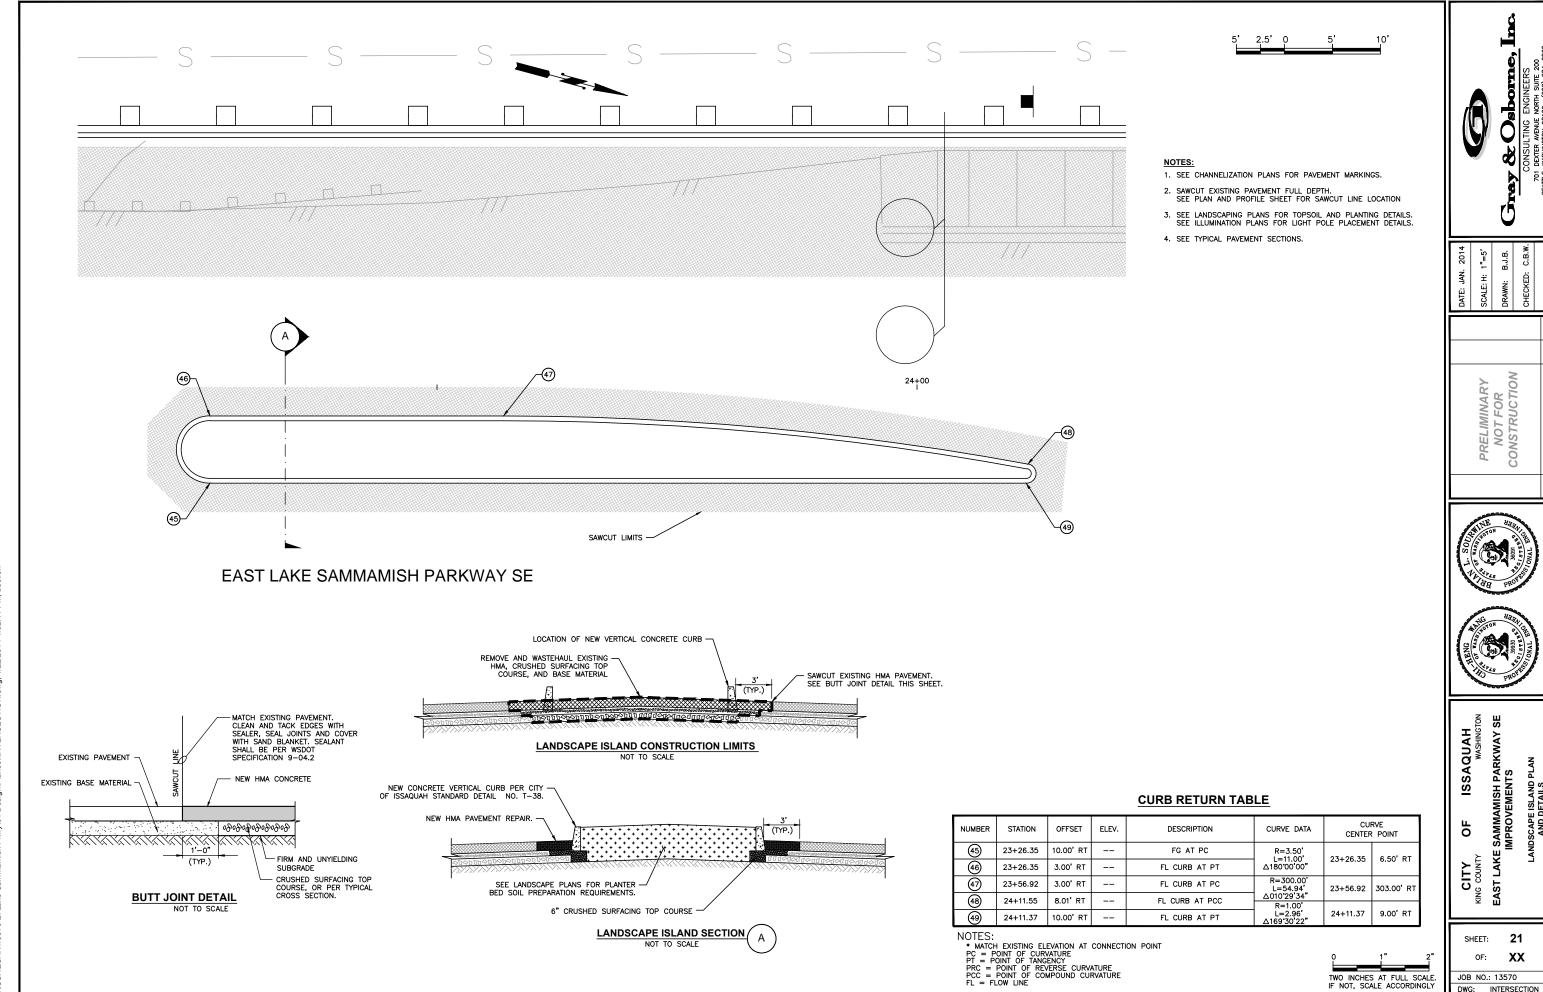
* MATCH EXISTING ELEVATION AT CONNECTION POINT PC = POINT OF CURVATURE PT = POINT OF TANGENCY PRC = POINT OF REVERSE CURVATURE PCC = POINT OF COMPOUND CURVATURE FL = FLOW LINE



EAST LAKE SAMMAMISH PARKWAY SE IMPROVEMENTS

21

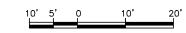XX





TRAIL CONTROL


| NUMBER | STATION | OFFSET | ELEV. | DESCRIPTION | CURVE DATA | | RVE POINT |
|-----------|----------|-----------|-------|-------------------------|-------------------------|----------|--------------|
| 50 | 19+84.53 | 42.51' LT | | FG AT BACK OF WALK | | | |
| (51) | 20+55.51 | 42.51' LT | | FG AT BACK OF WALK/PC | R=42.00' L=43.51' | 20+55.51 | 84.51' LT |
| 52 | 20+88.70 | 63.94' LT | | FG AT BACK OF WALK/PCC | Δ059*21'16" R=15.00' | | |
| 53 | 20+78.85 | 85.89' LT | | FG AT TIE IN POINT * | L=28.66' Δ109'29'27" | 20+76.65 | 71.09' LT |
| 54) | 19+84.53 | 34.51' LT | | FG AT FRONT OF WALK | | | |
| 65 | 20+55.51 | 34.51' LT | | FG AT FRONT OF WALK/PC | R=50.00' L=61.87' | 20+55.51 | 84.51' LT |
| 56 | 20+98.60 | 69.56' LT | | FG AT FRONT OF WALK/PRC | Δ070*53'40" R=15.00' | | |
| 67 | 21+13.39 | 80.55' LT | | FG AT TIE IN POINT * | L=21.47' △082'01'10" | 21+11.84 | 65.65' LT |

NOTES:

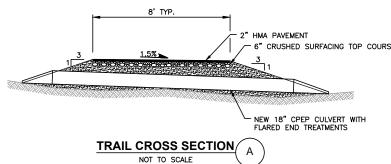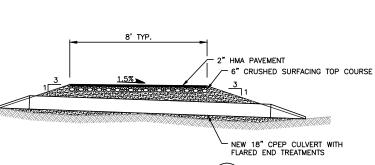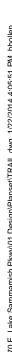* MATCH EXISTING ELEVATION AT CONNECTION POINT PC = POINT OF CURVATURE PT = POINT OF TANGENCY PRC = POINT OF REVERSE CURVATURE PCC = POINT OF COMPOUND CURVATURE FL = FLOW LINE







PRELIMINARY NOT FOR CONSTRUCTION

ISSAQUAH WASHINGTON

OF

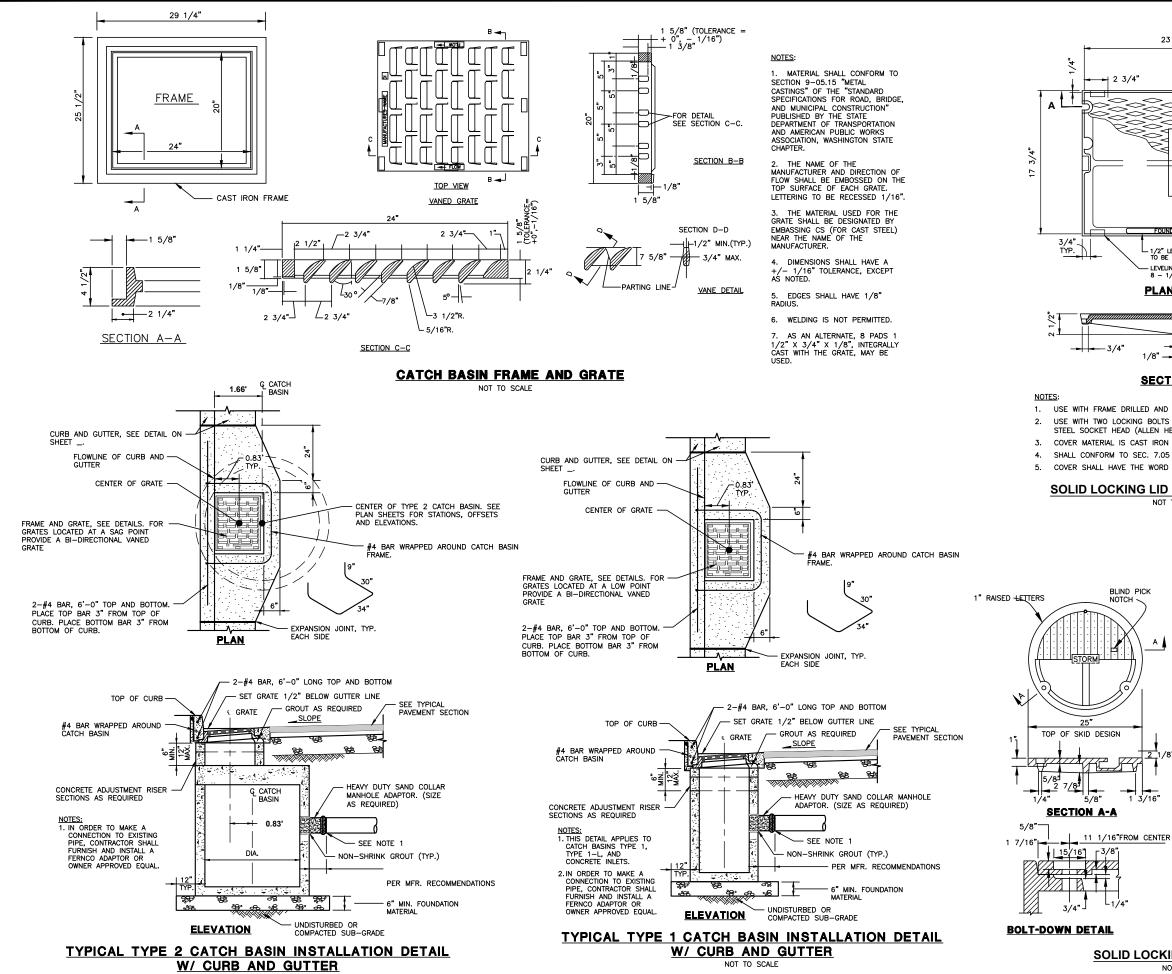
SHEET:

JOB NO.: 13570


EAST LAKE SAMMAMISH PARKWAY SE IMPROVEMENTS

22

XX



NOT TO SCALE

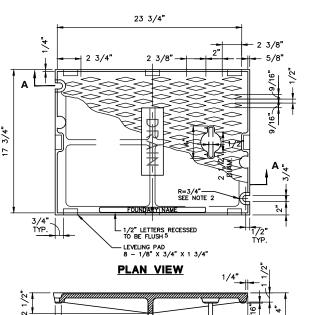

SECTION A-A

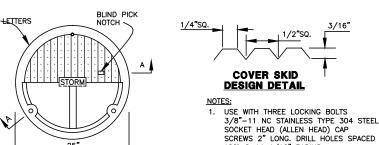
1/8" ---

4 3/4"


FINISH DIM. ON

- 1. USE WITH FRAME DRILLED AND TAPPED FOR LOCKING BOLTS.
- USE WITH TWO LOCKING BOLTS 5/8"-11 NC STAINLESS STEEL TYPE 304 STEEL SOCKET HEAD (ALLEN HEAD) BOLTS, 2" LONG.
- COVER MATERIAL IS CAST IRON PER ASTM A48 CLASS 30.
- SHALL CONFORM TO SEC. 7.05 OF THE STANDARD SPECIFICATIONS
- 5. COVER SHALL HAVE THE WORD "DRAIN" IN 2-INCH RAISED LETTERS.

SOLID LOCKING LID (TYPE 1 CATCH BASIN) NOT TO SCALE



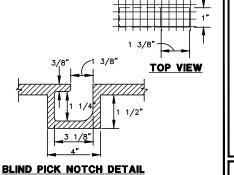- SOCKET HEAD (ALLEN HEAD) CAP SCREWS 2" LONG. DRILL HOLES SPACED 120° @ 11 1/16" RADIUS
- 2. MATERIAL IS DUCTILE IRON ASTM A 536 GRADE 80-55-06.



NOT TO SCALE

SOLID LOCKING LID (MANHOLE)

DRAWN

PRELIMINARY NOT FOR CONSTRUCTION

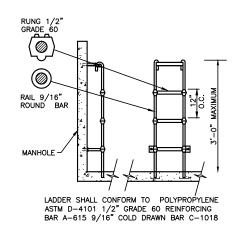




SE ISSAQUAH WASHINGT AISH PARKWAY S MENTS P LAKE CITY


IG COUNT EAST

23 SHEET: OF: XX JOB NO.: 13570 DWG: DRAINAGE_DET1



POLYPROPYLENE MANHOLE STEPS POLYPROPYLENE LADDER

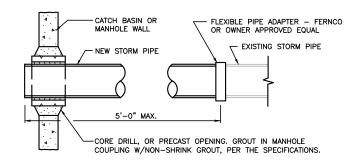POLYPROPYLENE LADDER AND MANHOLE STEPS




CONNECTION OF EXISTING STORM DRAIN USING FLEXIBLE PIPE ADAPTER

NOT TO SCALE

NOTES


- 1 AS AN ACCEPTABLE ALTERNATE TO REBAR, WRE MESH HAVING A MINIMUM AREA OF 0.12 SQUARE INCHES PER FOOT MAY BE USED. WIRE MESH SHALL NOT BE PLACED IN KNOCKOUTS.
- 2 THE KNOCKOUT DIAMETER SHALL NOT BE GREATER THAN 20". KNOCKOUTS SHALL HAVE A WALL
 THICKNESS OF 2" MINIMUM TO 2 1/2" MAXIMUM.
- 3 THE MAXIMUM DEPTH FROM THE FINISHED GRADE TO THE PIPE INVERT SHALL BE 5'.
- 4 FRAME AND GRATE MAY BE INSTALLED WITH FLANGE DOWN OR CAST INTO ADJUSTMENT
- 5 THE PRECAST BASE SECTION MAY HAVE A ROUNDED FLOOR AND THE WALLS MAY BE SLOPED AT A RATE OF 1:24 OR STEEPER.
- 6 OPENING SHALL BE MEASURED AT THE TOP OF THE PRECAST BASE UNIT.
- OR 12" 7 GROUT ALL JOINTS INSIDE AND OUTSIDE.

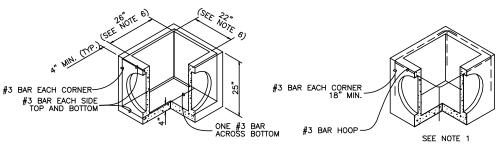ONE #3 BAR HOOP FOR 6" HEIGHT TWO #3 BAR HOOPS FOR 12" HEIGHT



CONCRETE INLET DETAIL

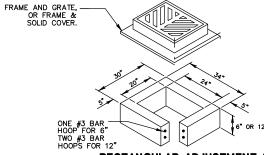
NOT TO SCALE



FRAME AND GRATE,

OR FRAME W/ SOLID COVER, PER DETAILS

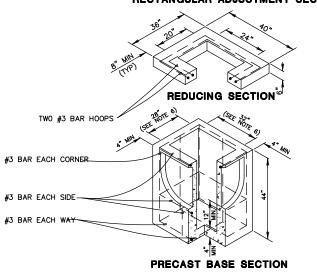RECTANGULAR ADJUSTMENT SECTION



NOTES

- 1 AS AN ACCEPTABLE ALTERNATE TO REBAR, WRE MESH HAVING A MINIMUM AREA OF 0.12 SQUARE INCHES PER FOOT MAY BE USED. WIRE MESH SHALL NOT BE PLACED IN KNOCKOUTS.
- 2 THE KNOCKOUT DIAMETER SHALL NOT BE GREATER THAN 20". KNOCKOUTS SHALL HAVE A WALL THICKNESS OF 2" MINIMUM TO 2 1/2" MAXIMUM.
- 3 THE MAXIMUM DEPTH FROM THE FINISHED GRADE TO THE PIPE INVERT SHALL BE 5'.
- 4 FRAME AND GRATE MAY BE INSTALLED WITH FLANGE DOWN OR CAST INTO ADJUSTMENT SECTION.
- 5 THE PRECAST BASE SECTION MAY HAVE A ROUNDED FLOOR AND THE WALLS MAY BE SLOPED AT A RATE OF 1: 24 OR STEEPER.
- 6 OPENING SHALL BE MEASURED AT THE TOP OF THE PRECAST BASE UNIT.
- 7 THE 6" ADJUSTMENT SECTION SHALL HAVE ONE #3 BAR CENTERED. THE 12" ADJUSTMENT SECTION SHALL HAVE TWO #3 BAR EQUALY SPACED.
- 8 GROUT ALL JOINTS INSIDE AND OUTSIDE.
- CATCH BASIN AND ALL REINFORCING STEEL TO CONFORM TO WSDOT STANDARD PLAN B-5.40-01
- * SEE ALSO TYPICAL CATCH BASIN TYPE 1 INSTALLATION DETAIL W/ CURB AND GUTTER, SHEET 23.

NOT TO SCALE





DRAWN

PRELIMINARY NOT FOR CONSTRUCTION





ISSAQUAH WASHINGTO

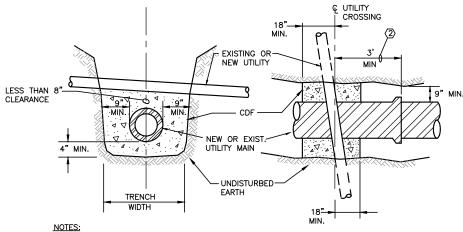
SAMMAMISH PARKWAY

DRAINAGE DETAILS

OF EAST LAKE CITY
to count

24 SHEET: XX JOB NO.: 13570 DWG: DRAINAGE DET2


CATCH BASIN TYPE 1L



- (1) CONTRACTOR SHALL PROVIDE CDF PIPE ENCASEMENT AT ALL EXISTING UTILITY CROSSINGS IN THE EVENT THAT AN 8" SEPARATION CANNOT BE PROVIDED. THE CONTRACTOR SHALL FAMILIARIZE THEMSELVES WITH THE SITE UTILITIES TO ANTICIPATE PROVIDING AND INSTALLING CDF ENCASEMENTS WHERE
- $\begin{tabular}{llll} \hline \end{tabular} \begin{tabular}{lllll} \hline \end{tabular} \begin{tabular}{llllll} \hline \end{tabular} \begin{tabular}{lllll} \hline \end{tabular} \begin{tabular}{llllll} \hline \end{tabular}$

CDF PIPE ENCASEMENT DETAIL

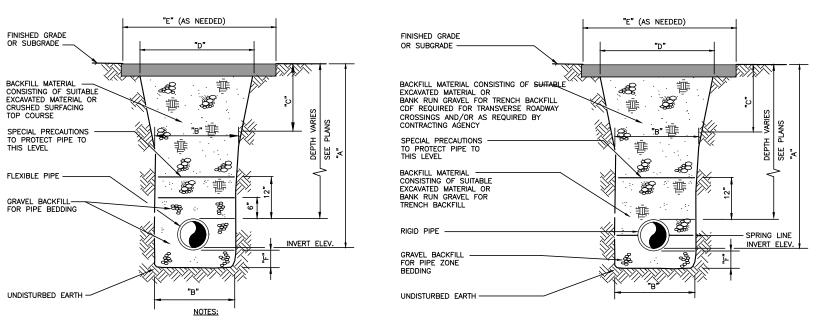NOT TO SCALE



1. THE TRENCH SECTIONS SHOWN ON THE PLANS ARE FOR THE PAYMENT LIMITS FOR BANK RUN GRAVEL FOR TRENCH BACKFILL. PAYMENT FOR ALL BANK RUN GRAVEL FOR TRENCH BACKFILL SHALL BE COMPUTED FROM THE MEASUREMENT OF THE CONSTRUCTED TRENCH SECTION, TO THE MAXIMUM LIMITS AS INDICATED IN THE TABLES.

2. WHERE A "NEW ROADWAY SECTION" OR PAVEMENT REPAIR IS PROPOSED, THE TRENCH SECTION PAYMENT LIMIT LINE WILL BE BOUNDED AT THE TOP BY PAVEMENT SUBGRADE, PER TYPICAL ROADWAY SECTION DETAILS.

TRENCH SECTION - FLEXIBLE STORM PIPE


NOT TO SCALE

TRENCH SECTION - RIGID STORM PIPE

8" & 12" DIAMETER PIPE

| | 6' OR | | | | | | | | | | | |
|---|-------|-------|-------|-------|-------|-------|-------|--------|--------|-------|-------|-------|
| Α | LESS | 8' | 10' | 12' | 14' | 16' | 18' | 20' | 22' | 24' | 26' | 28' |
| В | | 3.00' | | | | | | | | | | |
| С | 1.50' | 1.50' | 1.75 | 2.25' | 2.75 | 3.25' | 3.75' | 4.25 | 4.75' | 5.25' | 5.75' | 6.25' |
| D | 6.00' | 6.00' | 6.50' | 7.50' | 8.50' | 9.50' | 10.50 | 11.50' | 12.50' | 13.50 | 14.50 | 15.50 |
| E | 7.00' | 7.00' | 7.50' | 8.50' | 9.50 | 10.50 | 11.50 | 12.50' | 13.501 | 14.50 | 15.50 | 16.50 |
| F | | 4 in | | | | | | | | | | |

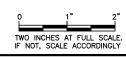TYPICAL TRENCH EXCAVATION LIMITS STORM SEWER PIPE





PRELIMINARY NOT FOR CONSTRUCTION



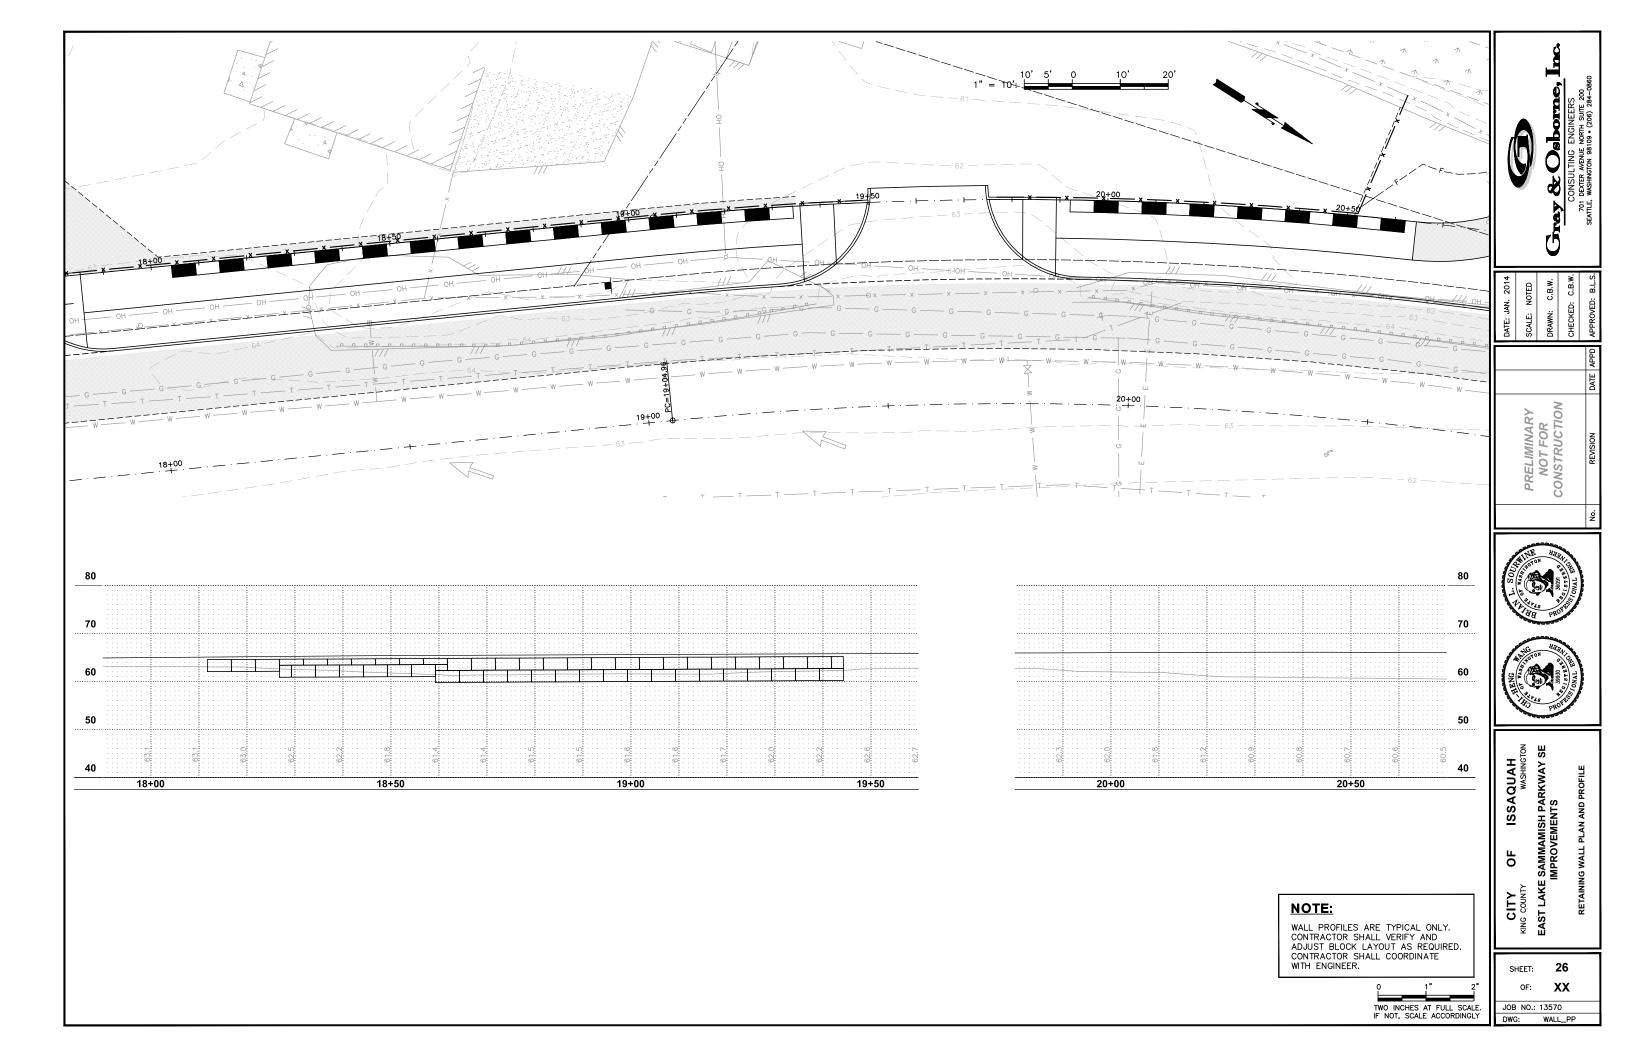
ISSAQUAH WASHINGTO

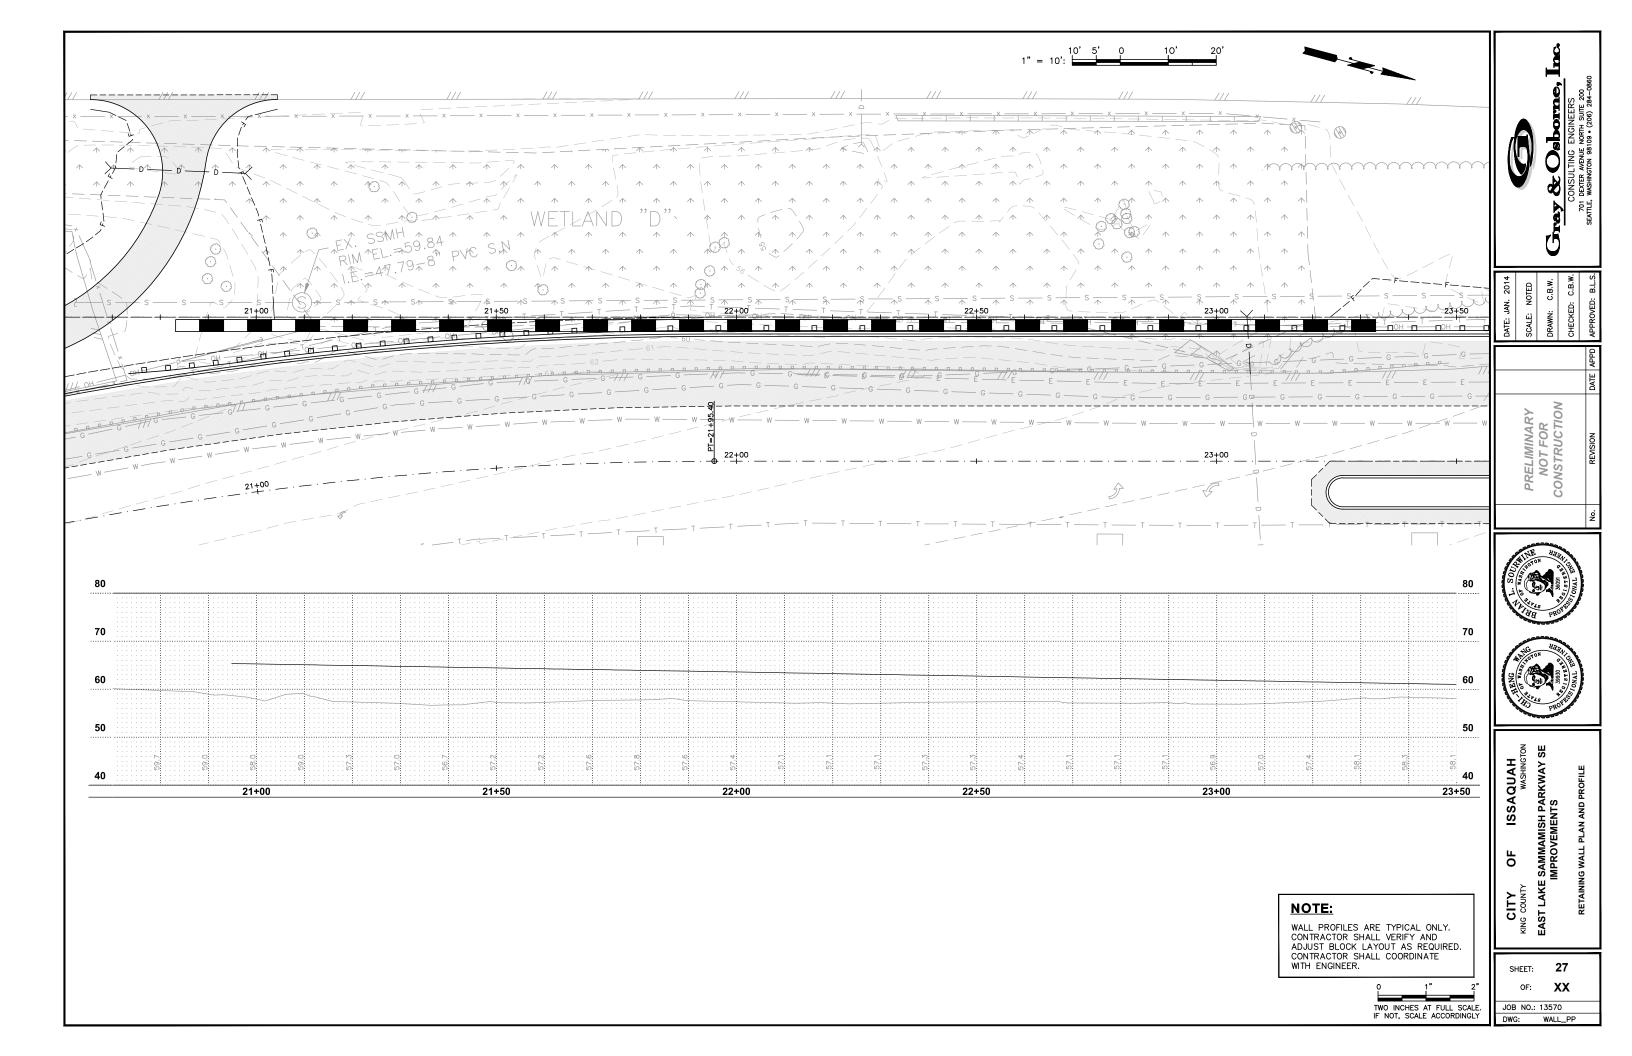
SAMMAMISH PARKWAY SE IMPROVEMENTS OF

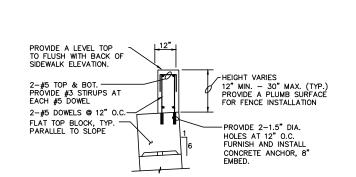
EAST LAKE CITY KING COUNTY XX

SHEET: JOB NO.: 13570

DWG: DRAINAGE_DET3







-CONTRACTOR SHALL CAST INTEGRAL WITH CONCRETE PANEL THE LOCK-BLOCK "+" PATTERN PER

MANUFACTURE'S RECOMMENDATIONS

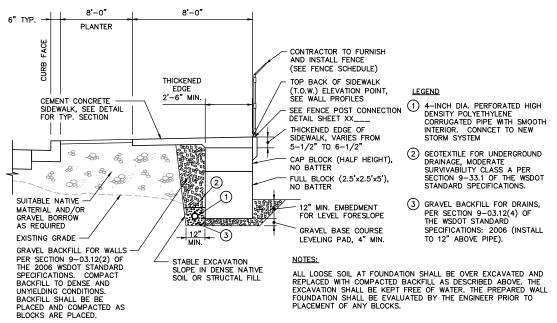
6-#3 STIRRUPS @ 6" O.C.

- 4-#5 CONTINUOUS

CONCRETE CAP DETAIL

FULL BLOCK, — TYP. PARALLEL TO SLOPE

2.5' CONC. PANEL W/ #5 VERT. @ 12" O.C. EA FACE #5 HORIZ. @ 12" O.C.




TYPICAL CROSS SECTION

SEGMENTAL BLOCK WALL (NO BATTER) APPROX. STA. 11+30 TO APPROX. STA. 17+30

NOT TO SCALE

NOTE:

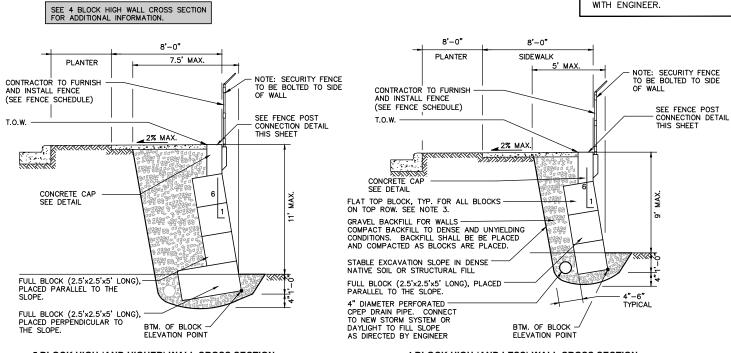WALL PROFILES ARE TYPICAL ONLY. CONTRACTOR SHALL VERIFY AND ADJUST BLOCK LAYOUT AS REQUIRED. CONTRACTOR SHALL COORDINATE



4 BLOCK HIGH (AND LESS) WALL CROSS SECTION

BLOCK WALL NOTES:

- ALL LOOSE SOIL AT ROCKERY FOUNDATION SHALL BE OVER EXCAVATED AND REPLACED WITH COMPACTED BACKFILL AS DESCRIBED ABOVE. THE EXCAVATION SHALL BE KEPT FREE OF WATER. THE PREPARED WALL FOUNDATION SHALL BE EVALUATED BY A SOILS ENGINEER PRIOR TO PLACEMENT OF ANY BLOCKS.
- 2. FOR TALLER WALL, PLACE AN ADDITIONAL ROW OF BLOCK, PERPENDICULAR TO THE SLOPE AT THE BOTTOM OF THE WALL. DO NOT EXCEED 6 BLOCKS TALL.
- 3. ALL BLOCKS LOCATED ALONG THE TOP ROW SHALL BE FURNISHED WITH A FLAT TOP.

SEGMENTAL BLOCK WALL (WITH BATTER) NOT TO SCALE

TWO INCHES AT FULL SCALE IF NOT, SCALE ACCORDINGLY

28 SHEET: XX JOB NO.: 13570

DRAWN

PRELIMINARY NOT FOR CONSTRUCTION

SAMMAMISH PARKWAY SE IMPROVEMENTS

LAKE

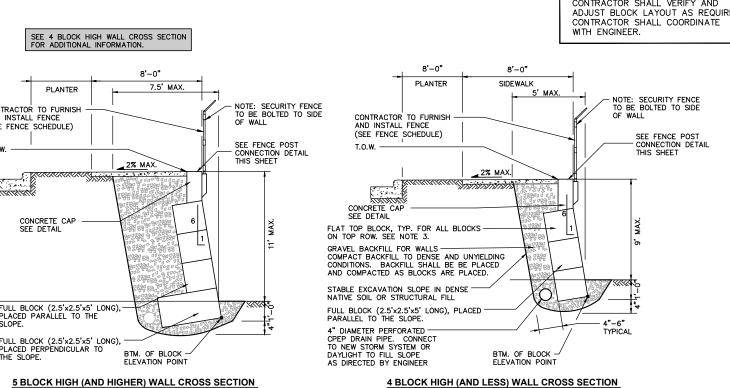
EAST

DETAILS

ISSAQUAH WASHINGTO

OF

CITY
SE COUNT



2-#5 CONT. EA. FACE 2.5' CONC. PANEL W/ CUI VERT @ CULVERT #5 VERT. @ 12" O.C. EA FACE #5 HORIZ. @ 12" O.C. SIZE AND TYPE VARY, SEE PLANS TYP. PANEL SECTION PANEL SECTION AT CULVERT VARIES - SEE PLANS FULL BLOCK, TYP. PARALLEL — TO SLOPE #3 CT STIRRUP: - 2-#5 CONT. EACH FACE FULL BLOCK, TYP. PERPENDICULAR TO #5x3'-0" TRIM BARS FRONT & BACK GROUND

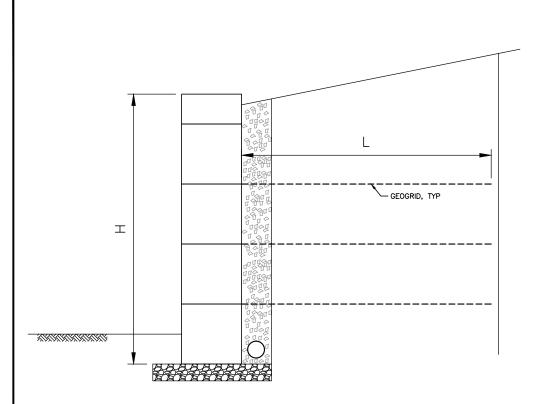
FULL BLOCK,— TYP. PARALLEL

CONTRACTOR SHALL

RECOMMENDATIONS

PROVIDE LOCK-BLOCK
"+" PER MANUFACTURE'S

CEMENT CONCRETE PANEL (TYP.) SCALE: 3/8"=1'-0"



TYPICAL CROSS SECTION

SEGMENTAL COCRETE BLOCK MSE WALL (NO BATTER)

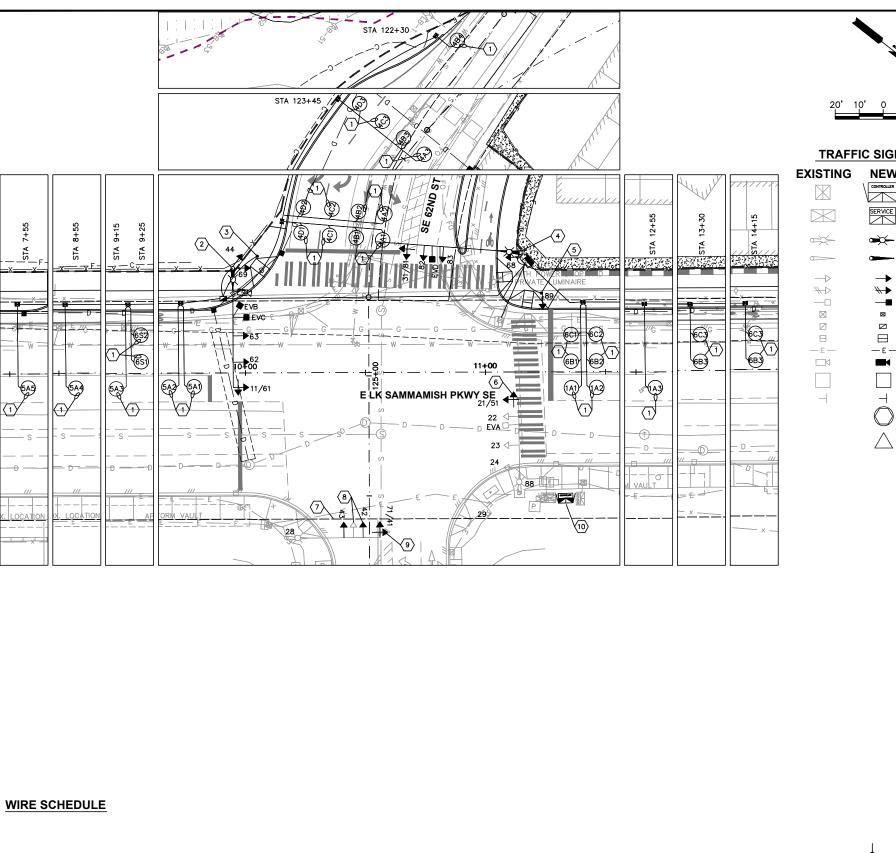
NOT TO SCALE

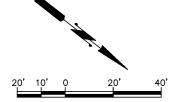




CITY OF NASHING. COUNTY WASHING. COUNTY EAST LAKE SAMMAMISH PARKWAY SE IMPROVEMENTS

SHEET: **29** XX OF: JOB NO.: 13570 DWG: WALL_2





TRAFFIC SIGNAL SYMBOL LEGEND

NEW **DESCRIPTION**

CONTROLLER CONTROLLER CABINET SERVICE SERVICE / ILLUMINATION CABINET TYPE III STEEL-MASTARM-SIGNAL

> TYPE II STEEL MAST-ARM SIGNAL VEHICLE SIGNAL HEAD PEDESTRIAN SIGNAL HEAD

POLE WITH LUMINAIRE

OPTICAL DETECTOR TYPE I JUNCTION BOX TYPE 2 JUNCTION BOX TYPE 8 JUNCTION BOX CONDUIT VIDEO CAMERA

VIDEO DETECTION ZONES

MAST ARM SIGN

SIGNAL POLE CONSTRUCTION NOTE

MAST ARM SIGN LEGEND

18

s-2 18"

SE 62ND ST

WSDOT SIGN CODE D3-401

WSDOT SIGN CODE D3-301

E LK SAMMAMISH PKWY

WIRE NOTE

TRAFFIC SIGNAL CONSTRUCTION NOTES

- $\fbox{1}$ contractor shall provide and install round traffic detector loop per city of issaquah standard plan ts=02 and ts=03.
- (2) EXCAVATE AND CONSTRUCT FOUNDATION PER SIGNAL STANDARD SHEET AND WSDOT STD. PLAN J-26.10-02. PROVIDE AND INSTALL TYPE III SIGNAL POLE AND MAST ARM PER SIGNAL STANDARD SHEET, 1-250 WATT COBRA HEAD FIXTURE AND 16' LUMINAIRE ARM, 2 EMERGENCY PREEMPTION DETECTOR, 3 VEHICLE SIGNAL HEADS, 1 PEDESTRIAN SIGNAL HEAD, 1 PAN-TILT-ZOOM(PTZ) CAMERA. PROVIDE AND INSTALL STREET NAME SIGN.

KING COUNTY

- 3 EXCAVATE AND CONSTRUCT FOUNDATION PER SIGNAL STANDARD SHEET AND WSDOT STD. PLAN J-21.10-03. PROVIDE AND INSTALL TYPE PPB SIGNAL POLE WITH SLIP BASE, AND 1 ACCESSIBLE PEDESTRIAN DETECTOR.
- 4 EXCAVATE AND CONSTRUCT FOUNDATION PER SIGNAL STANDARD SHEET AND WSDOT STD. PLAN J-26.10-02. PROVIDE AND INSTALL TYPE III SIGNAL POLE AND MAST ARM PER SIGNAL STANDARD SHEET, 1-250 WATT COBRA HEAD FIXTURE AND 16'
 LUMINAIRE ARM, 1 EMERGENCY PREEMPTION DETECTOR, 3 VEHICLE SIGNAL HEADS, 1
 PEDESTRIAN SIGNAL HEAD. PROVIDE AND INSTALL STREET NAME SIGN.
- (5) EXCAVATE AND CONSTRUCT FOUNDATION PER SIGNAL STANDARD SHEET AND WSDOT STD. PLAN J-21.10-03. PROVIDE AND INSTALL TYPE PPB SIGNAL POLE WITH SLIP BASE, 1 PEDESTRIAN SIGNAL HEAD, 1 ACCESSIBLE PEDESTRIAN DETECTOR.
- 6 REMOVE EXISTING 3 SECTION SIGNAL DISPLAY. PROVIDE AND INSTALL 4-SECTION SIGNAL DISPLAY WITH FLASHING YELLOW ARROW. PROVIDE AND INSTALL ASSOCIATED WIRING TO TERMINAL CABINET AND CONTROLLER.
- 7 PROVIDE AND INSTALL 3-SECTION SIGNAL DISPLAY WITH ASTROBRACKET MOUNT.
 PROVIDE AND INSTALL ASSOCIATED WIRING TO TERMINAL CABINET AND CONTROLLER.
- 8 RELOCATE EXISTING 3-SECTION SIGNAL HEAD TO EXISTING TENON AS SHOWN.
 PROVIDE AND INSTALL ASSOCIATED WRING TO TERMINAL CABINET AND CONTROLLER.
- 9 REMOVE EXISTING 5-SECTION(DOGHOUSE) SIGNAL DISPLAY. PROVIDE AND INSTALL 4-SECTION SIGNAL DISPLAY WITH FLASHING YELLOW ARROW. PROVIDE AND INSTALL ASSOCIATED WIRING TO TERMINAL CABINET AND CONTROLLER.
- 10 EXCAVATE AND CONSTRUCT SERVICE AND CONTROLLER FOUNDATION PER CITY OF ISSAQUAH STANDARD PLAN TS-11. PROVIDE AND INSTALL CONTROLLER CABINET WITH ASSOCIATED CONTROLLER EQUIPMENT, CONTRACTOR SHALL COORDINATE WITH CITY OF ISSAQUAH FOR CONTROLLER DELIVERY



21/51,41/71

G Y/G 22,23,24,42,43,44 62,63,82,83 11/61,31/81,

PEDESTRIAN SIGNAL HEADS

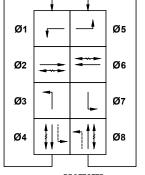


68.69.88.89

SIGNAL DISPLAY NOTES

- ALL VEHICLE AND PEDESTRIAN SIGNAL HEADS SHALL HAVE LED DISPLAYS.
 ALL VEHICLE HEADS SHALL BE ALUMINUM WITH 12" LENSES AND ALUMINUM TUNNEL VISORS. BACKPLATES SHALL BE INSTALLED IN ACCORDANCE WITH STANDARD SPECIFICATION 9-29.16.
- 3. VEHICLE SIGNAL HEADS SHALL HAVE TYPE M MOUNT PER WSDOT STD PLAN J-75.20-00
 4. PEDESTRIAN SIGNAL HEADS SHALL HAVE COUNTDOWN DISPLAYS.
 5. PEDESTRIAN SIGNAL HEAD 68,69,88 AND 89 SHALL HAVE TYPE E MOUNT PER WSDOT STD PLAN J-75.10-01.





PERMISSIVE
PEDESTRIAN

| PREEMPTION | | | | | | |
|-------------------|-------|---------|--|--|--|--|
| SCHEDULE | | | | | | |
| | PHASE | CHANNEL | | | | |
| | Ø2 | Α | | | | |
| | Ø4 | В | | | | |
| | Øε | | | | | |

Ø8 D

| CITY OF ISSAQUAH KING COUNTY WASHINGT EAST LAKE SAMMAMISH PARKWAY (IMPROVEMENTS) |
|--|
|--|

ISSAQUAH WASHINGTO


| 30 |
|--------|
| XX |
| 13570 |
| SIGNAL |
| |


701 I SEATTLE,

AN.


PRELIMINARY NOT FOR CONSTRUCTIC

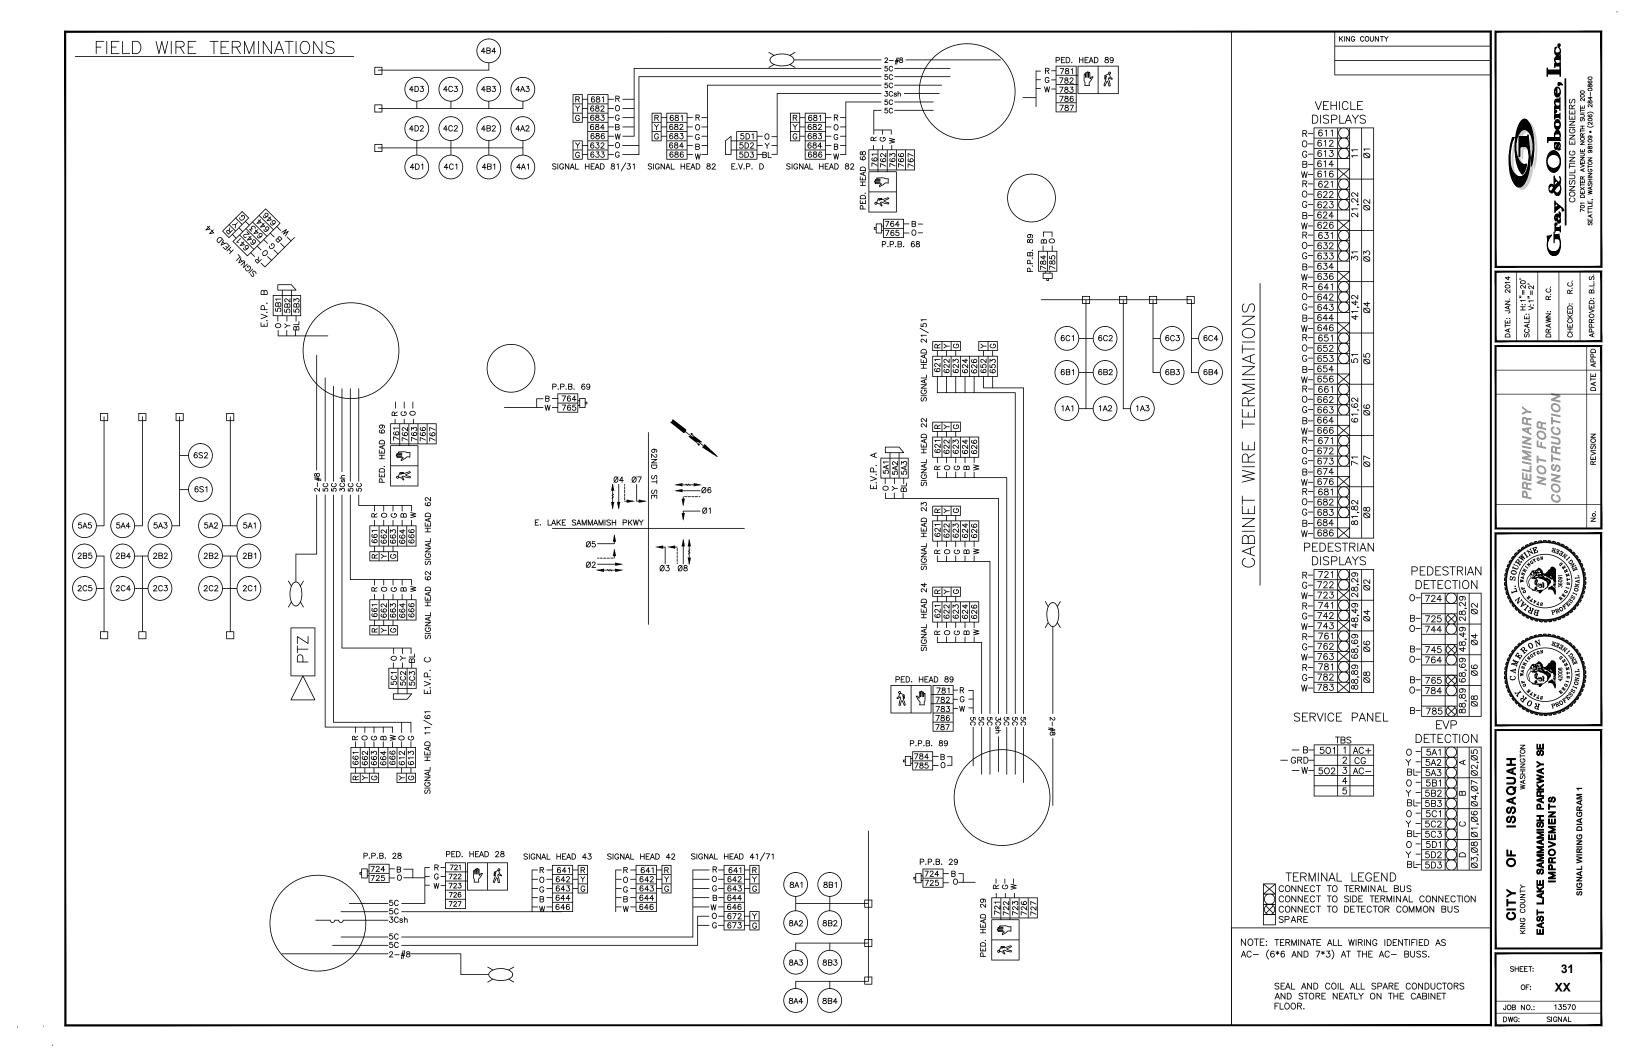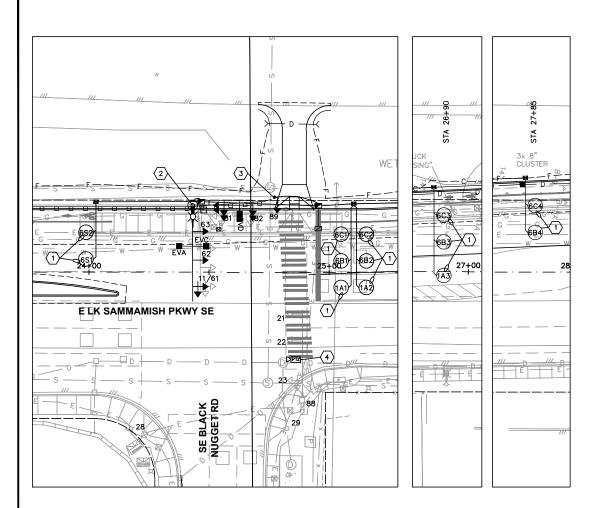- PROTECTED





WIRE SCHEDULE

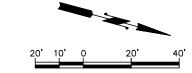

TRAFFIC SIGNAL SYMBOL LEGEND

| TRAFFIC SIGNAL STWIBOL LEGEND | | | | | | | |
|-------------------------------|--------------------------|--|--|--|--|--|--|
| EXISTING | NEW | DESCRIPTION | | | | | |
| | CONTROLLER | CONTROLLER CABINET | | | | | |
| \mathbb{X} | SERVICE | SERVICE / ILLUMINATION CABINET | | | | | |
| | $\Rightarrow \leftarrow$ | TYPE III STEEL-MASTARM-SIGNAL POLE WITH LUMINAIRE | | | | | |
| 0 | | TYPE II STEEL MAST-ARM SIGNAL POLE | | | | | |
| \longrightarrow | → | VEHICLE SIGNAL HEAD | | | | | |
| \ | ₩• | PEDESTRIAN SIGNAL HEAD | | | | | |
| — | | OPTICAL DETECTOR | | | | | |
| \boxtimes | ⊠ | TYPE I JUNCTION BOX | | | | | |
| | | TYPE 2 JUNCTION BOX | | | | | |
| | | TYPE 8 JUNCTION BOX | | | | | |
| — E — | — E — | CONDUIT | | | | | |
| | | VIDEO CAMERA | | | | | |
| | | VIDEO DETECTION ZONES | | | | | |
| \dashv | \dashv | MAST ARM SIGN | | | | | |
| | | SIGNAL POLE CONSTRUCTION NOTE | | | | | |

TRAFFIC SIGNAL CONSTRUCTION NOTES

- 1) CONTRACTOR SHALL PROVIDE AND INSTALL ROUND TRAFFIC DETECTOR LOOP PER CITY OF ISSAQUAH STANDARD PLAN TS-02 AND TS-03.
- 2) EXCAVATE AND CONSTRUCT FOUNDATION PER SIGNAL STANDARD SHEET AND WSDOT STD. PLAN J-26.10-02. PROVIDE AND INSTALL TYPE III SIGNAL POLE AND DUAL MAST ARM PER SIGNAL STANDARD SHEET, 1-250 WATT COBRA HEAD FIXTURE AND 16' LUMINAIRE ARM, 3 EMERGENCY PREEMPTION DETECTOR, 5 VEHICLE SIGNAL HEADS. PROVIDE AND INSTALL 2 STREET NAME SIGNS.

KING COUNTY

- 3 EXCAVATE AND CONSTRUCT FOUNDATION PER SIGNAL STANDARD SHEET AND WSDOT STD. PLAN J-21.10-03. PROVIDE AND INSTALL TYPE PS SIGNAL POLE WITH SLIP BASE, 1 PEDESTRIAN DISPLAY, AND 1 ACCESSIBLE PEDESTRIAN DETECTOR.
- PROVIDE AND INSTALL PAN-TILT-ZOOM(PTZ) CAMERA ON EXISTING LUMINAIRE ARM, WRING TO CONTROLLER, AND ASSOCIATED CONTROLLER EQUIPMENT. CONNECT TO PTZ CAMERA CONTROLLER TO THE CITY'S FIBER NETWORK.
- (8) RELOCATE EXISTING 3-SECTION SIGNAL HEAD TO EXISTING TENON AS SHOWN. PROVIDE AND INSTALL ASSOCIATED WIRING TO TERMINAL CABINET AND CONTROLLER.

PRELIMINARY NOT FOR CONSTRUCTION

DATE: JAN. 2014 SCALE: H:1"=20'

701 I SEATTLE,



G G Y/G G 21,22,23, 11/61

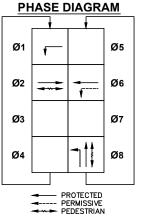




SIGNAL DISPLAY NOTES

- 1. ALL VEHICLE AND PEDESTRIAN SIGNAL HEADS SHALL HAVE LED DISPLAYS.
 2. ALL VEHICLE HEADS SHALL BE ALUMINUM WITH 12" LENSES AND ALUMINUM TUNNEL VISORS. BACKPLATES SHALL BE INSTALLED IN ACCORDANCE WITH STANDARD SPECIFICATION 9—29.16.
 3. VEHICLE SIGNAL HEADS SHALL HAVE TYPE M MOUNT PER WSDOT STD PLAN J—75.20—00 PEDESTRIAN SIGNAL HEADS SHALL HAVE TYPE D MOUNT PER WSDOT STD PLAN J—75.10—01.





| ļ | PREEMPTION SCHEDULE | | | | |
|---|---------------------|---------|---|--|--|
| | PHASE | CHANNEL | ı | | |
| | Ø2 | Α | | | |
| | | | | | |
| | Ø6 | С | | | |
| | Ø8 | D | | | |
| | | | | | |
| | | | | | |
| | | | | | |

32 SHEET: XX OF: 13570 JOB NO.: DWG. SIGNAL

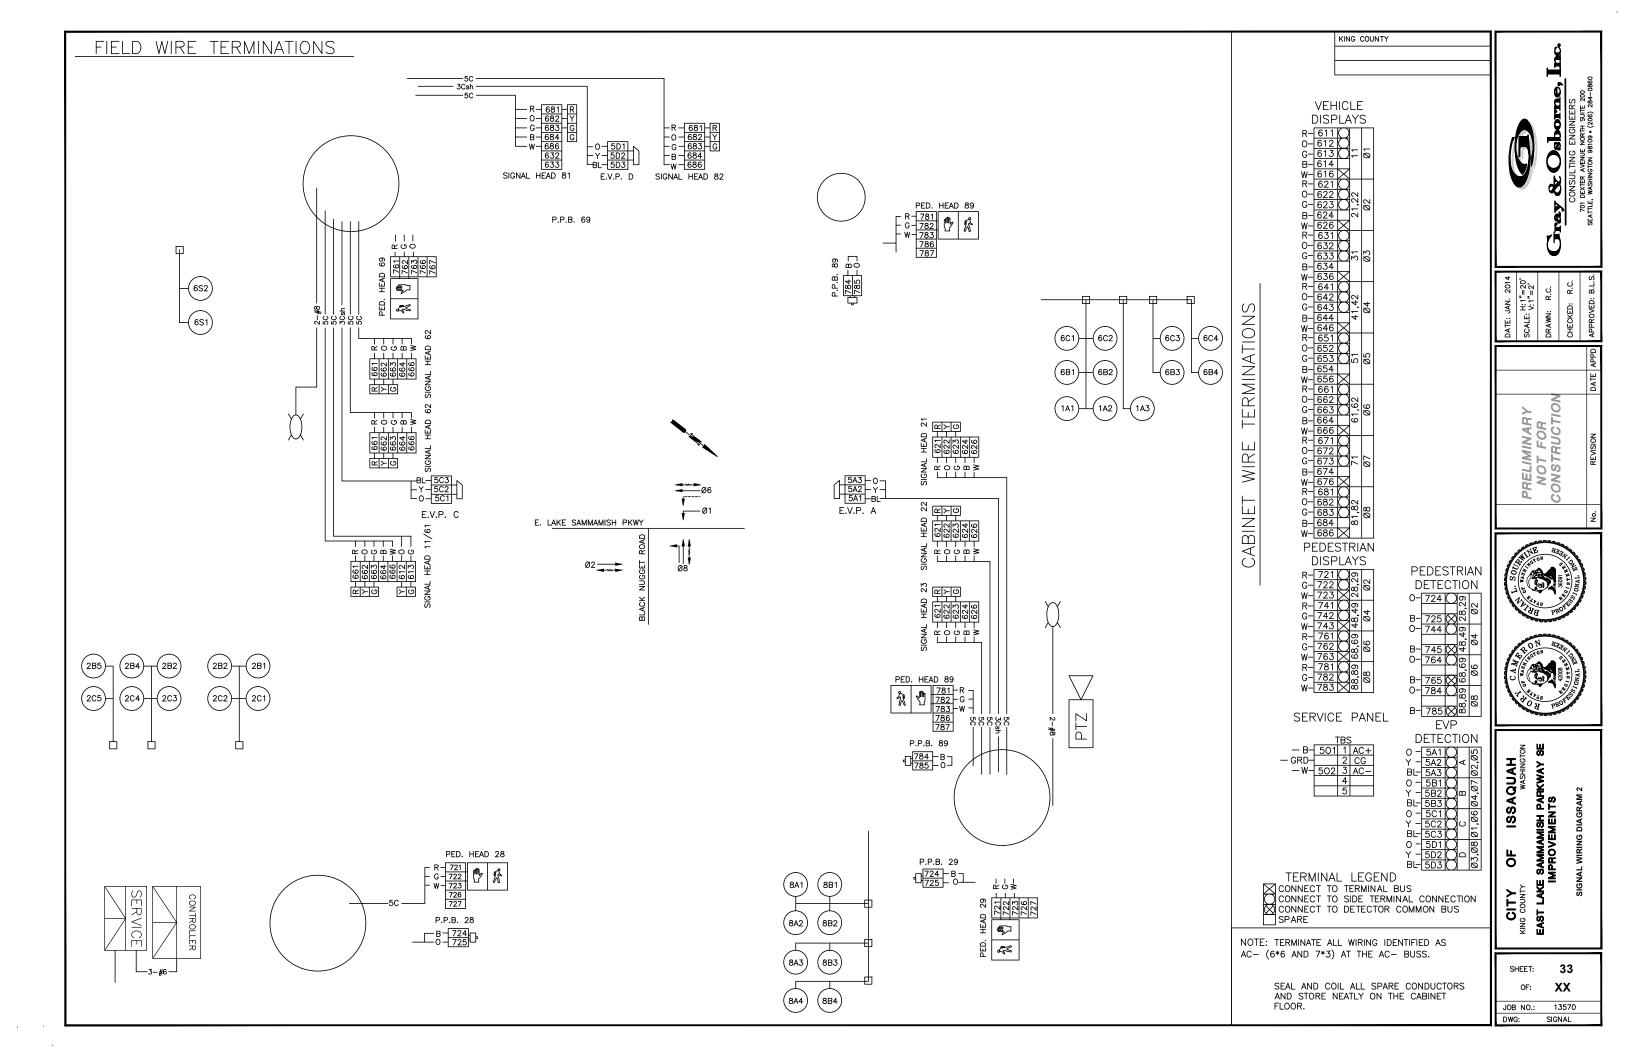
ISSAQUAH WASHINGTO

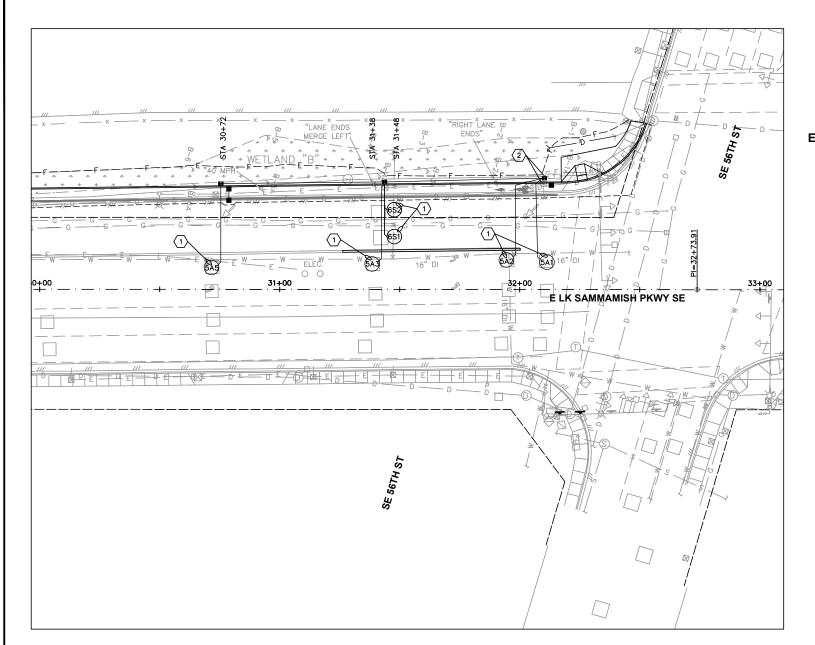
Р

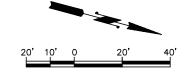
CITY Fig. 52

SAMMAMISH PARKWAY

s-2 18"







TRAFFIC SIGNAL SYMBOL LEGEND

| XISTING | NEW | DESCRIPTION |
|---|--------------------------|--|
| \mathbb{X} | CONTROLLER | CONTROLLER CABINET |
| \mathbb{X} | SERVICE | SERVICE / ILLUMINATION CABINET |
| ======================================= | $\Rightarrow \leftarrow$ | TYPE III STEEL-MASTARM-SIGNAL POLE WITH LUMINAIRE |
| 0 | | TYPE II STEEL MAST-ARM SIGNAL POLE |
| \longrightarrow | → | VEHICLE SIGNAL HEAD |
| \ | ₩ → | PEDESTRIAN SIGNAL HEAD |
| — | - | OPTICAL DETECTOR |
| \boxtimes | ⊠ | TYPE I JUNCTION BOX |
| | | TYPE 2 JUNCTION BOX |
| \Box | | TYPE 8 JUNCTION BOX |
| -E- | — E — | CONDUIT |
| | | VIDEO CAMERA |
| | | VIDEO DETECTION ZONES |
| \dashv | \dashv | MAST ARM SIGN |
| | | SIGNAL POLE CONSTRUCTION NOTE |
| | \triangle | WIRE NOTE |
| | | |

TRAFFIC SIGNAL CONSTRUCTION NOTES

1) CONTRACTOR SHALL PROVIDE AND INSTALL ROUND TRAFFIC DETECTOR LOOP PER CITY OF ISSAQUAH STANDARD PLAN TS-02 AND TS-03.

KING COUNTY

2 PULL EXISTING WIRE IN EXISTING JUNCTION BOX TO NEAREST JUNCTION BOX TO MAINTAIN CONTINUOUS LINE TO CONTROLLER. INTERCEPT EXISTING CONDUIT AND ROUTE EXISTING CONDUIT TO PROPOSED JUNCTION BOX PER CITY OF ISSAQUAH STANDARD PLAN TS-06



DATE: JAN. 2014
SCALE: V:1"=20'
DRAWN: R.C.

PRELIMINARY NOT FOR CONSTRUCTION





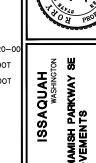
PEDESTRIAN

SIGNAL HEADS

SIGNAL DISPLAY NOTES

1. ALL VEHICLE AND PEDESTRIAN SIGNAL HEADS SHALL HAVE LED DISPLAYS.
2. ALL VEHICLE HEADS SHALL BE ALUMINUM WITH 12" LENSES AND ALUMINUM TUNNEL VISORS. BACKPLATES SHALL BE INSTALLED IN ACCORDANCE WITH STANDARD SPECIFICATION 9-29.16.
3. VEHICLE SIGNAL HEADS SHALL HAVE TYPE M MOUNT PER WSDOT STD PLAN J-75.20-00 4. PEDESTRIAN SIGNAL HEADS SHALL HAVE COUNTDOWN DISPLAYS.
5. PEDESTRIAN SIGNAL HEAD 28,48,68, AND 88 SHALL HAVE TYPE E MOUNT PER WSDOT STD PLAN J-75.10-01.
6. PEDESTRIAN SIGNAL HEAD 29,49,69, AND 89 SHALL HAVE TYPE D MOUNT PER WSDOT STD PLAN J-75.10-01.


22,42, 62,82



| ISSAQI ™ | ST LAKE SAMMAMISH PAFIKN IMPROVEMENTS |
|----------------|--|
| P | SAMMA |
| CITY COUNTY | ST LAKE |

| SHEET: | 34 |
|----------|--------|
| OF: | XX |
| JOB NO.: | 13570 |
| DWG: | SIGNAL |
| | |

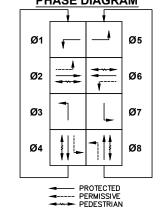MAST ARM SIGN LEGEND 12" 507 First St S s-1 18' WSDOT SIGN CODE D3-401 s-2 18" Mosman Ave SE WSDOT SIGN CODE D3-301





VEHICLE SIGNAL HEADS

11/61,31/81,

| PH | IASE [| DIAGR | <u>AM</u> | PREEMPTION SCHEDULE |
|----------|----------|-----------------------|-----------|-------------------------------|
| Ø1 | - | | Ø5 | PHASE CHANNEL Ø2 A |
| | 4 | | ۔ ۔ | Ø4 B Ø6 C |
| Ø2 | | T | Ø6 | Ø8 □ VIDEO DETECTION |
| | | | | |
| Ø3 | 1 | | Ø7 | SCHEDULE |
| Ø3 | 1 | | Ø7 | SCHEDULE PHASE CHANNEL Ø2 A |
| Ø3 Ø4 | 1 | _ | Ø7 Ø8 | PHASE CHANNEL Ø2 A Ø4 B |
| | | - - | | PHASE CHANNEL Ø2 A |

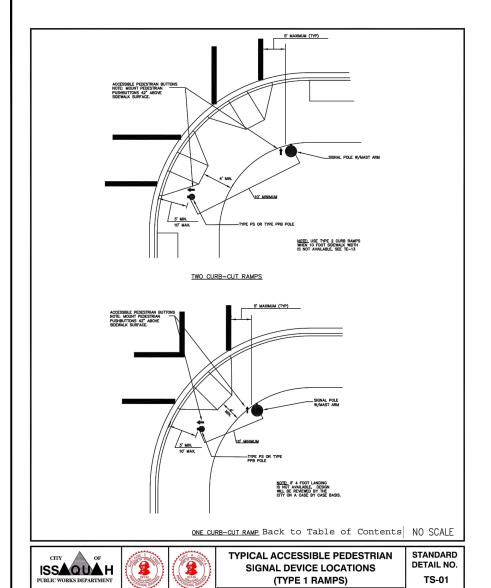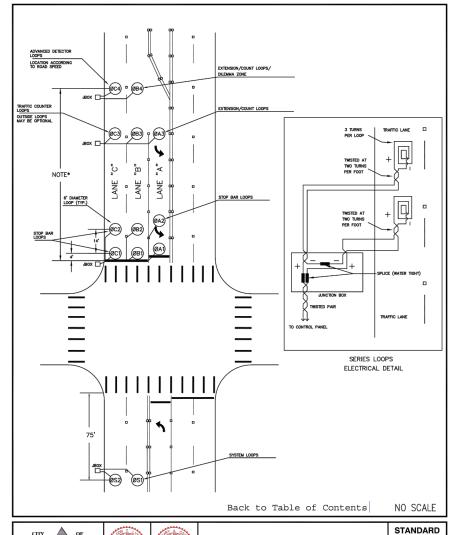WIRE SCHEDULE






TRAFFIC LOOP DETAIL

(SHEET 1 OF 3)


DETAIL NO.

TS-02

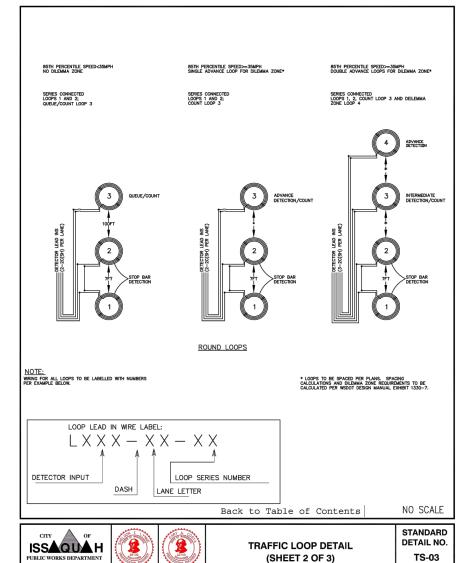ISSAQUA H



KING COUNTY

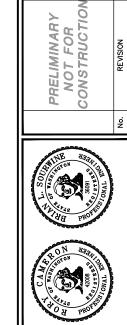



DATE: JAN. 2014
SCALE: V:1"=2'
DRAWN: R.C.





CITY OF ISSAQUAH
KING COUNTY WASHINGTON
EAST LAKE SAMMAMISH PARKWAY SE
IMPROVEMENTS CITY KING COUNTY

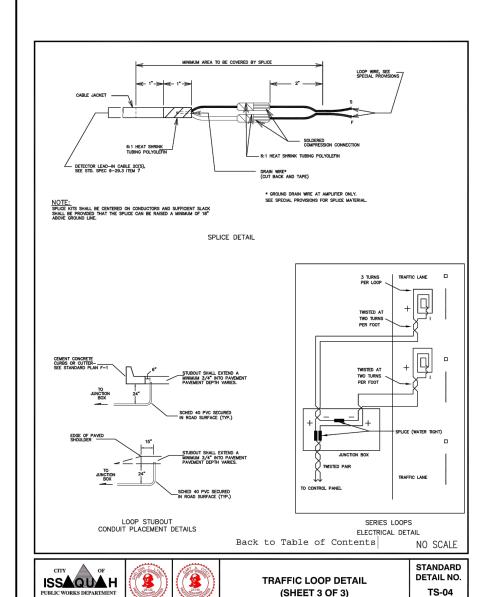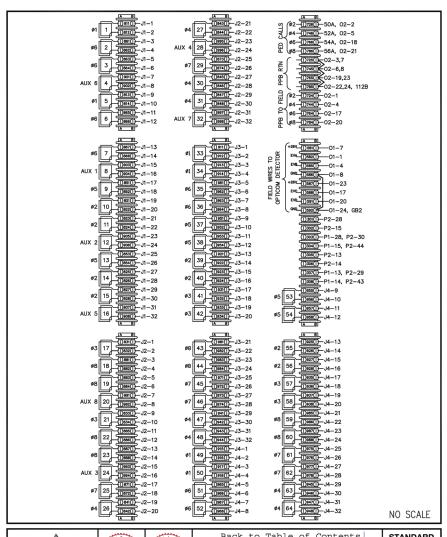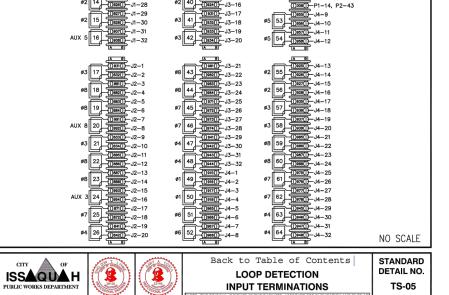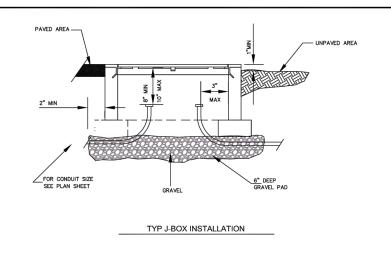35 SHEET: XX OF: JOB NO.: 13570 SIGNAL DWG:









KING COUNTY

NOTES:

- 1. ALL DIMENSIONS ARE MINIMUM. EXACT CONFIGURATIONS VARY AMONG DIFFERENT MANUFACTURERS.
- THE NOTED LID THICKNESSES ARE OVERALL MINIMUMS. THE DIAMOND PATTERN FOR TYPE 1 OR TYPE 2 BOXES SHALL BE 28% MINIMUM OF OVERALL THICKNESS. THE DIAMOND PATTERN FOR TYPE 8 BOXES SHALL BE 3/322 MINIMUM THICK.
- 3. LID SUPPORT MEMBERS SHALL BE WELDED TO FRAME.
- 4. 4000 PSI CONCRETE IS ALLOWED IF BOX REINFORCEMENT CONSISTS OF 6x6-W3xW3 WELDED WIRE FABRIC WELDED TO THE FRAME.
- WHEN NOTED IN THE CONTRACT TYPE 2 AND TYPE 8 BOXES SHALL BE PROVIDED WITH 12" DEEP EXTENSION BOXES.
- 6. WHEN NOTED IN THE CONTRACT TYPE 2 BOXES SHALL BE PROVIDED WITH A 10"x27 1/2" 10 GAGE DIVIDER PLATE COMPLETE WITH FASTENERS.
- NON CONCRETE BOXES MAY BE SUBMITTED FOR APPROVAL EVALUATION WILL INCLUDE AN H-20 LOAD TEST.
- 8. ALL BOXES WILL BE CITY OF ISSAQUAH ENGINEER APPROVED AND CERTIFIED
- LEGEND FOR TRAFFIC SIGNAL SYSTEM BOXES WILL BE "TS", AND "LT" FOR ILLUMINATION SYSTEMS.
 LEGEND FOR COMMUNICATIONS OR FIBER SYSTEM BOXES WILL BE "COM".
 LEGEND LETTERS WILL BE FORMED WITH 1/8" WELD BEAD. GRIND OFF DIAMOND PATTERN BEFORE
 FORMING LETTERS.
- 10. JUNCTION BOXES WITHIN SIDEWALK SHALL HAVE NO-SKID LIDS.

Back to Table of Contents





TRAFFIC SIGNAL JUNCTION BOX DETAILS

ISSAQUAH WASHINGT

DATE: JAN. 2014 SCALE: H:1"=20'

PRELIMINARY NOT FOR CONSTRUCTION

CHECKED: DRAWN:

SAMMAMISH PARKWAY IMPROVEMENTS Р CITY


| SHEET: | 36 XX | |
|----------|----------|--|
| OF: | | |
| JOB NO.: | 13570 | |
| DWG: | SIGNAL | |










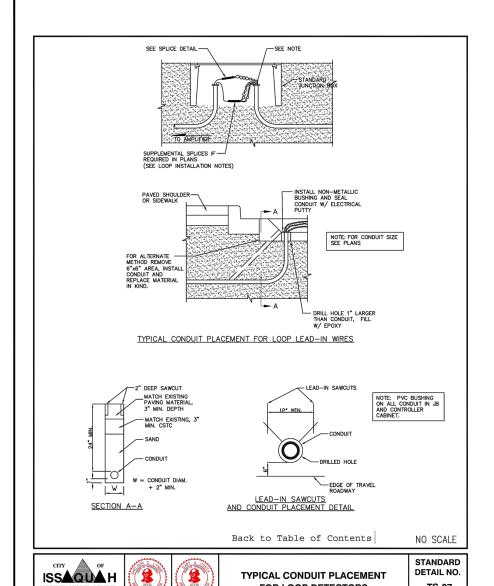

AUGUST 2010

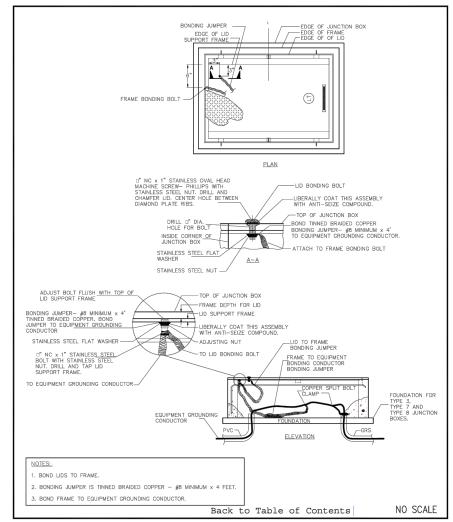FOR LOOP DETECTORS



TYPE 1,2,3,7, & 8 JUNCTION BOX

EXISTING FRAME &

LID BONDING DETAIL

ISSAQUA H

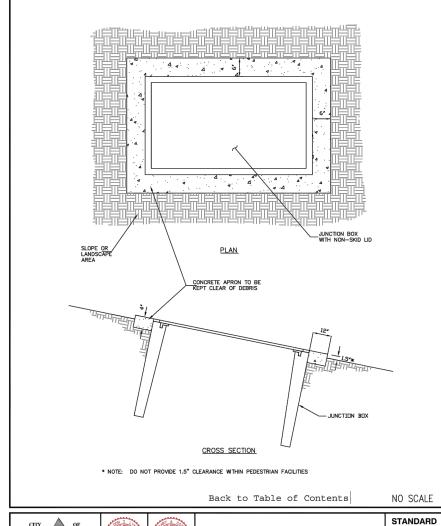
TS-07

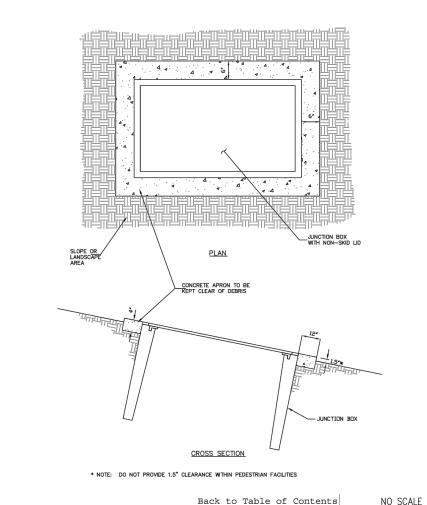
STANDARD

DETAIL NO.

TS-08

ISSAQUA H





JUNCTION BOX ON GRADE

FOR LANDSCAPE AREAS

KING COUNTY



PRELIMINARY NOT FOR CONSTRUCTION

DATE: JAN. 2014
SCALE: H:1"=20'
DRAWN: R.C.

снескер:



ISSAQUAH WASHINGTO

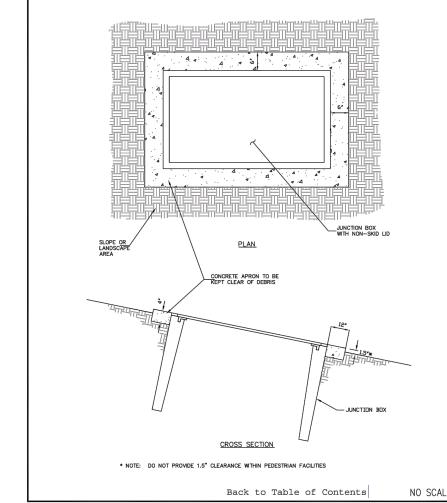
DETAIL NO.

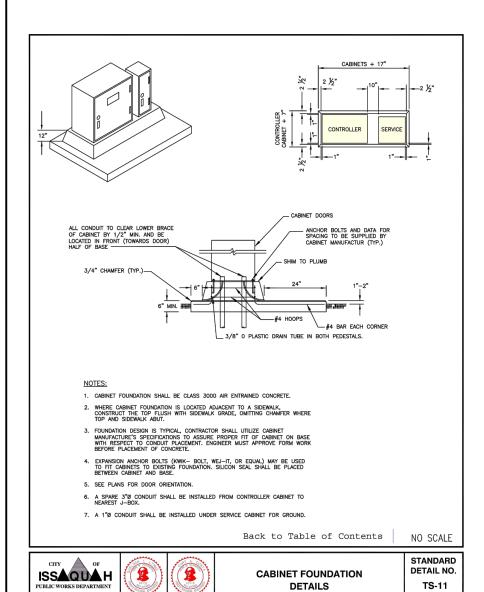
TS-09

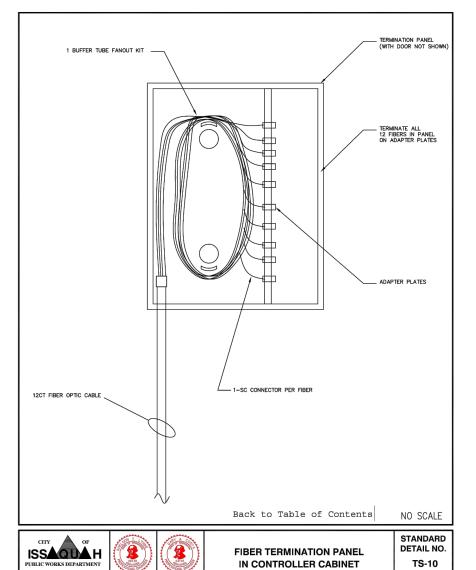
EAST LAKE SAMMAMISH PARKWAY SE IMPROVEMENTS Ю

CITY KING COUNTY

37 SHEET: XX OF: 13570 JOB NO.: SIGNAL DWG:







IN CONTROLLER CABINET

TS-10



CITY KING COUNTY

SHEET:

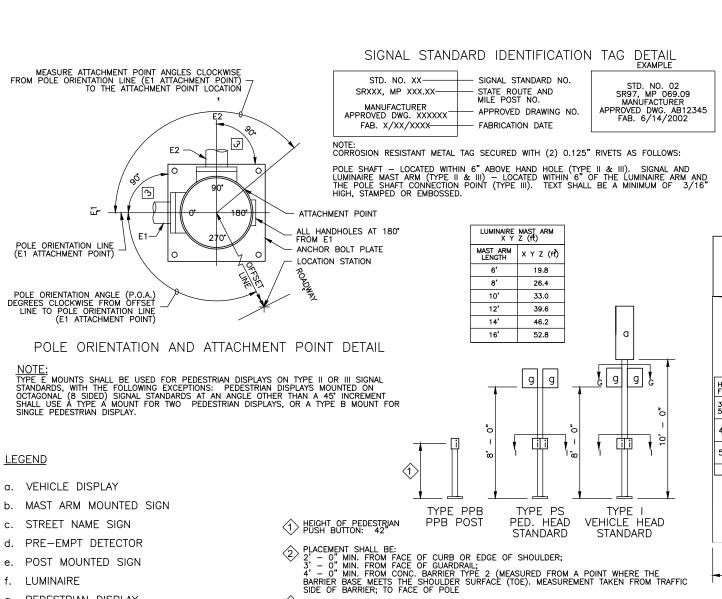
DWG:

OF: JOB NO.: 38

XX

13570 SIGNAL

KING COUNTY



NOTES

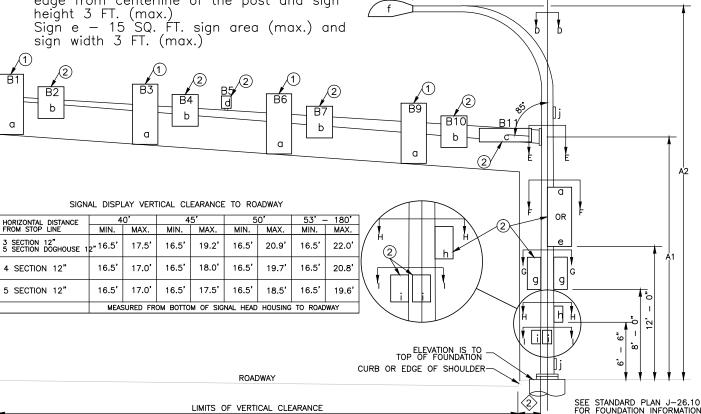
① Mounting Coupling installed at offset distance indicated in chart.

② Field installed. Sign b - 7.5 SQ. FT. sign area (max.) and sign height 3 FT. (max.) Sign c — 36 SQ. FT. sign area (max.) installed 1'-0" min. and 2'-6" max. to sign edge from centerline of the post and sign

ALTERNATE NOTE 1 FOR TYPE N MOUNT ONLY.

KING COUNTY

① Drill 1" diam. hole in mast arm and install plastic split bushing for cable entrance.



TYPE II, III & SD SIGNAL STANDARD

APPLY GROUT EVEN WITH THE BOTTOM OF THE ANCHOR PLATE AFTER PLUMBING THE STANDARD, PROVIDE $3/8^{\prime\prime}$ DIAMETER DRAIN TUBE IN THE GROUT PAD

ISSAQUAH WASHINGT SAMMAMISH PARKWAY MPROVEMENTS Я

DATE: JAN. 2014 SCALE: H:1"=20'

DRAWN:

PRELIMINARY NOT FOR CONSTRUCTION

CITY Fig. 52

SHEET: 39 XX OF: 13570 JOB NO.: DWG. SIGNAL

* CALCULATED POLE X Y Z (ft) IS THE SUM OF THE TOTAL X Y Z (ft) FOR THE SIGNAL ARM AND THE X Y Z (ft) FOR THE LUMINAIRE ARM (IF PRESENT)

3 DMS OR VMS IS NOT ALLOWED ON THIS POLE.

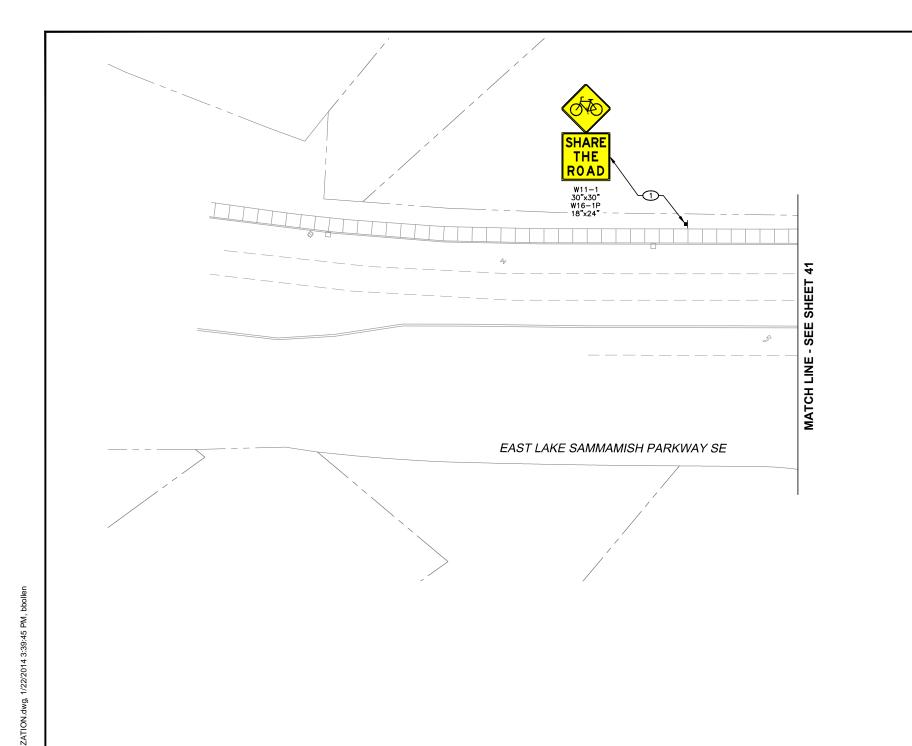
 $\stackrel{\textstyle \leftarrow}{4}$ for post mounted signs there shall be 2' - 0" Min. From the face of the curb or the edge of the shoulder to the edge of the sign

g. PEDESTRIAN DISPLAY

CABINET

PPB-M

HANDHOLE





GENERAL

○ CHANNELIZATION NOTES:

- 1. CONTRACTOR SHALL REMOVE EXISTING PAVEMENT MARKINGS/ PRM'S/ OTHER CHANNELIZATION MARKINGS. COORDINATE WORK WITH THE ENGINEER.
- 2. CONTRACTOR SHALL FURNISH AND INSTALL WHITE WIDE LANE LINE PER CITY OF ISSAQUAH STANDARD DETAIL T-19.
- 3. CONTRACTOR SHALL FURNISH AND INSTALL WHITE BROKEN LINE PER CITY OF ISSAQUAH STANDARD DETAIL T-19.
- LINE PER CITY OF ISSAQUAH STANDARD DETAIL T-19.
- 5. CONTRACTOR SHALL FURNISH AND INSTALL TWO-WAY LEFT TURN LINE PER CITY OF ISSAQUAH STANDARD DETAIL T-19.
- 10. CONTRACTOR SHALL FURNISH AND INSTALL STOP BAR AND CROSSWALK STRIPES PER CITY OF ISSAQUAH STANDARD DETAIL T-36.
- 11. CONTRACTOR SHALL FURNISH AND INSTALL TYPE A CURBING PER CITY OF ISSAQUAH STANDARD DETAIL T—39.
- 12. CONTRACTOR SHALL FURNISH AND INSTALL VERTICAL CONCRETE CURB PER CITY OF ISSAQUAH STANDARD DETAIL T—38.



- 1. ALL SIGN TYPES, COLORS, AND DIMENSIONS ARE STANDARD PER THE MUTCD, UNLESS OTHERWISE INDICATED.
- 2. STREET NAME SIGNS SHALL MEET CITY STANDARD SIZE, DIMENSION, COLOR, ETC.

- 4. CONTRACTOR SHALL FURNISH AND INSTALL YELLOW DOUBLE
- 6. CONTRACTOR SHALL FURNISH AND INSTALL 6" WHITE METHYL METHACRYLATE FOG LINE PER CITY OF ISSAQUAH STANDARD
- CONTRACTOR SHALL INSTALL WHITE PAVEMENT ARROW(S) PER CITY OF ISSAQUAH STANDARD DETAIL T-35.
- 8. CONTRACTOR SHALL FURNISH AND INSTALL BICYCLE LANE SYMBOLS PER CITY OF ISSAQUAH STANDARD DETAIL T-27.
- 9. CONTRACTOR SHALL FURNISH AND INSTALL SHARROW BICYCLE LANE SYMBOLS PER CITY OF ISSAQUAH STANDARD DETAIL T-28.



- CONTRACTOR SHALL FURNISH AND INSTALL NEW SIGN AND POST PER CITY OF ISSAQUAH STANDARD DETAIL T-44.
- CONTRACTOR SHALL REMOVE AND WASTE HAUL EXISTING SIGN POST AND FOUNDATION AND DELIVER SIGN TO CITY OF ISSAQUAH PUBLIC WORKS DEPARTMENT.



SCALE: H:

DRAWN:

PRELIMINARY NOT FOR CONSTRUCTION



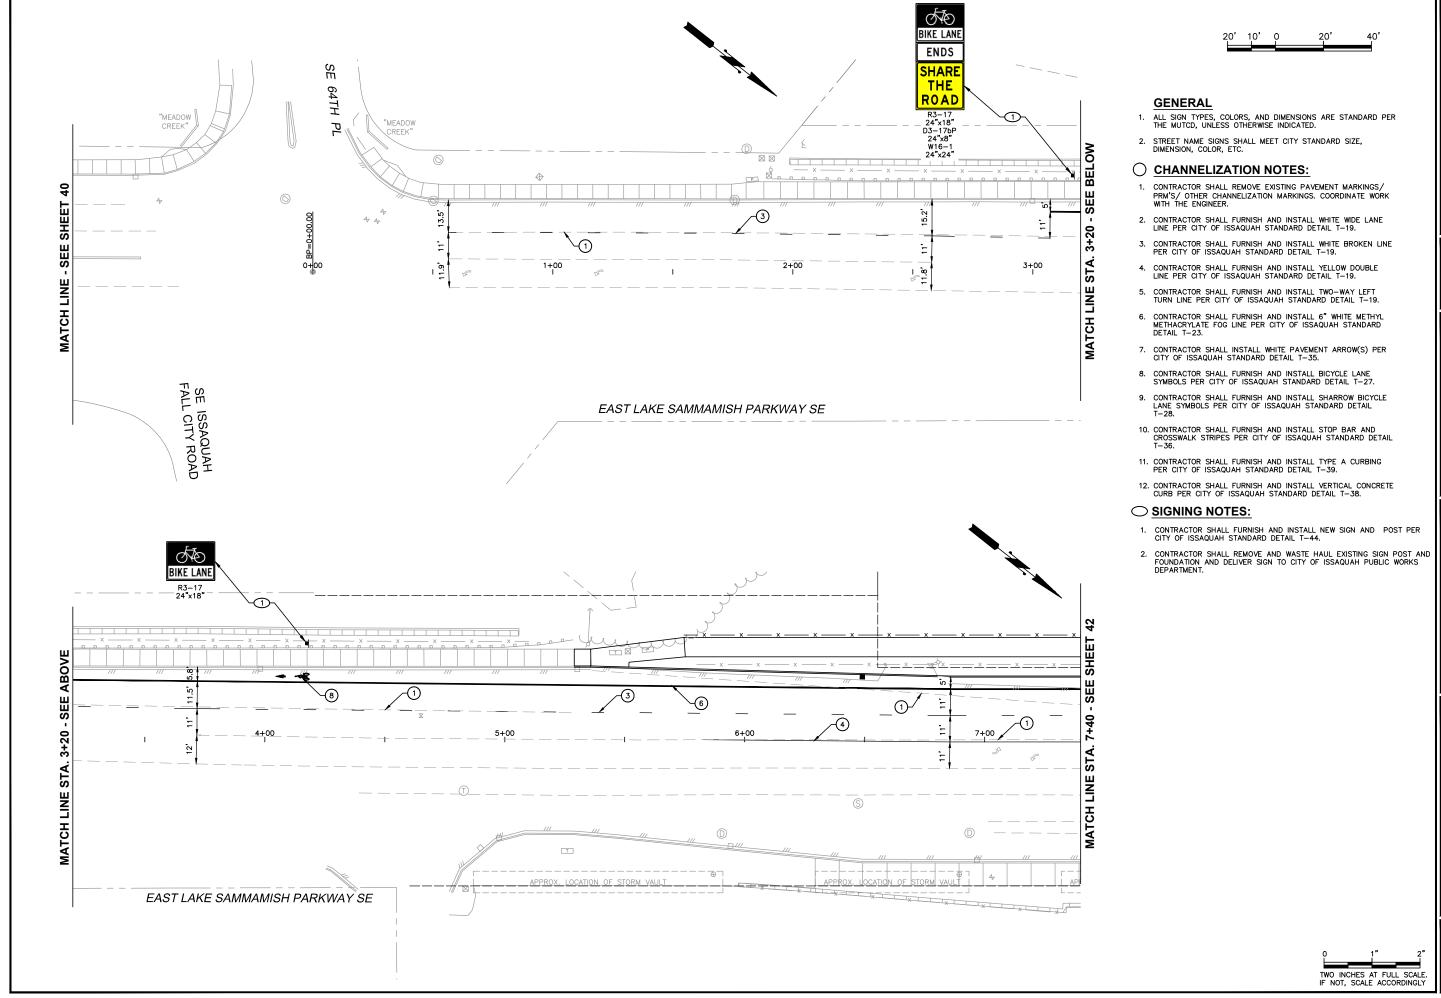


ISSAQUAH WASHINGTO

SAMMAMISH PARKWAY SE IMPROVEMENTS CHANNELIZATION & S DETAILS

О EAST LAKE CITY KING COUNTY

40 SHEET: XX JOB NO.: 13570 DWG: CHANNELIZATION



iray & Osbor

ED: C.B.W. | G.B.M. |

SCALE: H: 1"=20

DRAWN: B.J.B.

CHECKED: C.B.W

APPROVED: B.L.S

PRELIMINARY
NOT FOR
CONSTRUCTION
REVISION DATE A





ISSAQUAH WASHINGTON

OF

MASHINGTON

WASHINGTON

EAST LAKE SAMMAMISH PARKWAY SE

IMPROVEMENTS

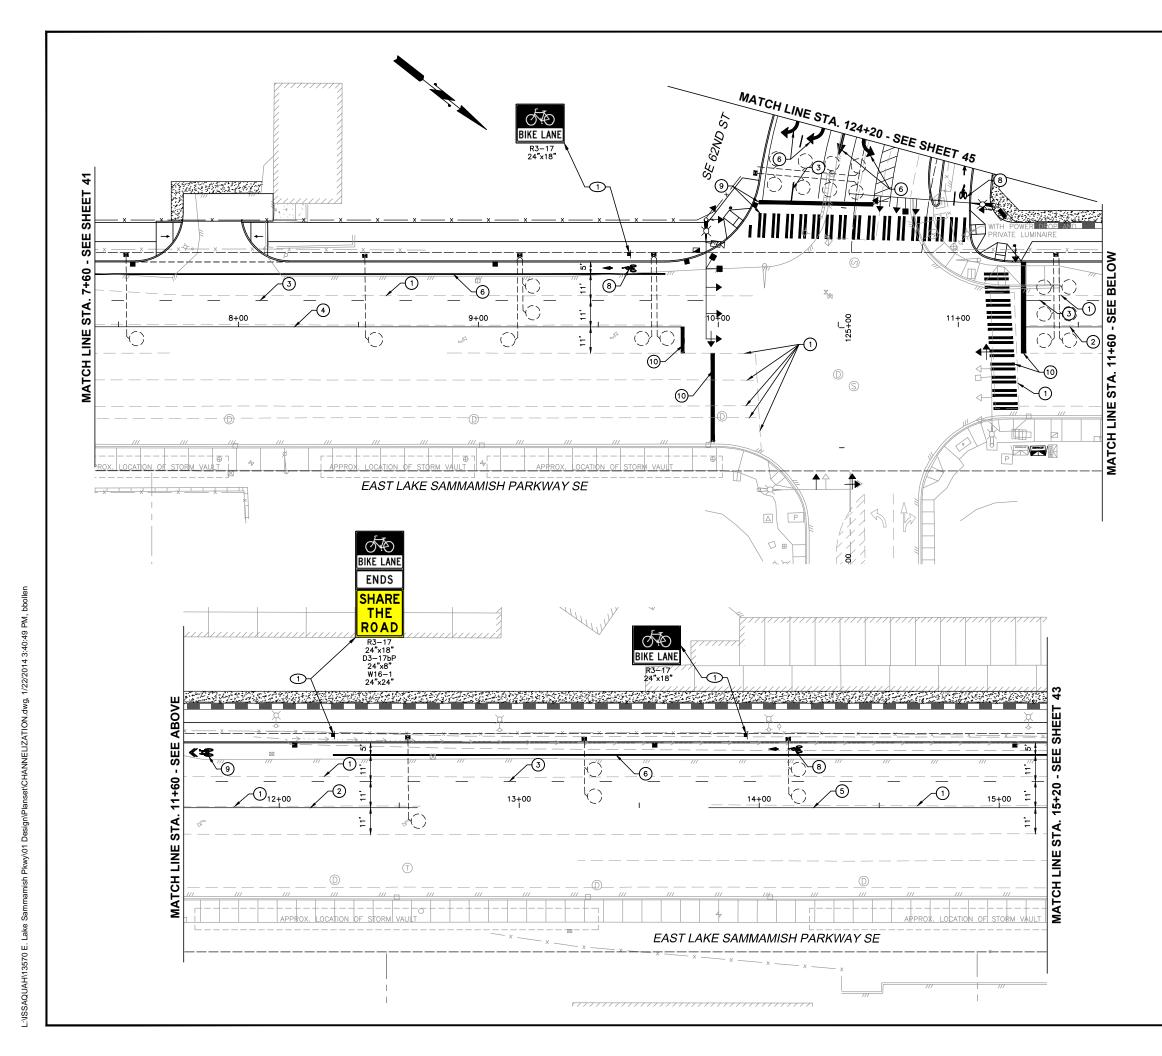
CITY
KING COUNTY
EAST LAKE

SHEET: 41

OF: XX

JOB NO.: 13570

DWG: CHANNELIZATION





GENERAL

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○ CHANNELIZATION NOTES:

- CONTRACTOR SHALL FURNISH AND INSTALL WHITE WIDE LANE LINE PER CITY OF ISSAQUAH STANDARD DETAIL T-19.
- 3. CONTRACTOR SHALL FURNISH AND INSTALL WHITE BROKEN LINE PER CITY OF ISSAQUAH STANDARD DETAIL T-19.
- 4. CONTRACTOR SHALL FURNISH AND INSTALL YELLOW DOUBLE LINE PER CITY OF ISSAQUAH STANDARD DETAIL T-19.
- 5. CONTRACTOR SHALL FURNISH AND INSTALL TWO-WAY LEFT TURN LINE PER CITY OF ISSAQUAH STANDARD DETAIL T-19.
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- 2. STREET NAME SIGNS SHALL MEET CITY STANDARD SIZE, DIMENSION, COLOR, ETC.

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- DETAIL T-23.
- 8. CONTRACTOR SHALL FURNISH AND INSTALL BICYCLE LANE SYMBOLS PER CITY OF ISSAQUAH STANDARD DETAIL T-27.
- 9. CONTRACTOR SHALL FURNISH AND INSTALL SHARROW BICYCLE LANE SYMBOLS PER CITY OF ISSAQUAH STANDARD DETAIL T-28.
- 10. CONTRACTOR SHALL FURNISH AND INSTALL STOP BAR AND CROSSWALK STRIPES PER CITY OF ISSAQUAH STANDARD DETAIL T-36.
- 11. CONTRACTOR SHALL FURNISH AND INSTALL TYPE A CURBING PER CITY OF ISSAQUAH STANDARD DETAIL T-39.
- 12. CONTRACTOR SHALL FURNISH AND INSTALL VERTICAL CONCRETE CURB PER CITY OF ISSAQUAH STANDARD DETAIL T-38.

○ SIGNING NOTES:

- CONTRACTOR SHALL FURNISH AND INSTALL NEW SIGN AND POST PER CITY OF ISSAQUAH STANDARD DETAIL T-44.





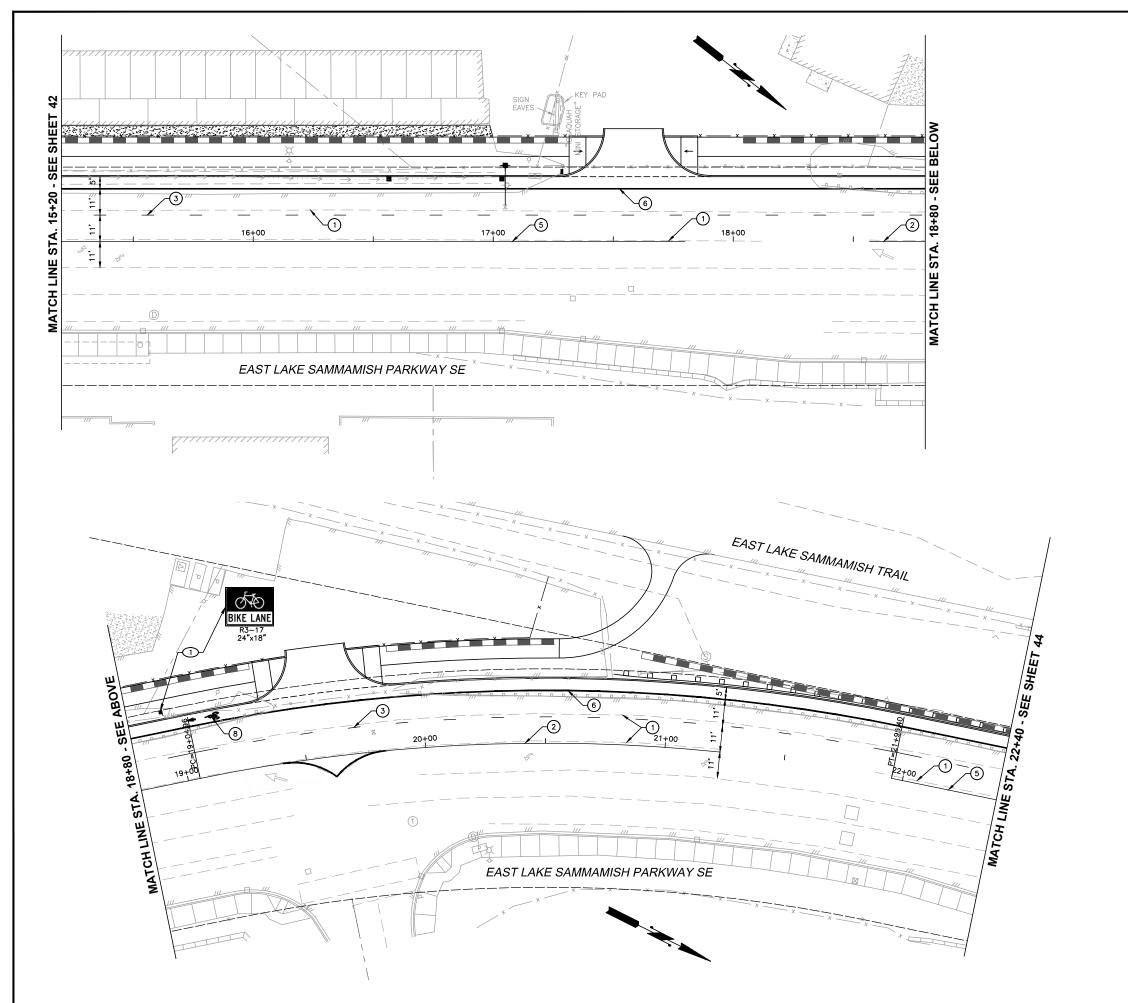


ISSAQUAH WASHINGTO О

EAST LAKE SAMMAMISH PARKWAY : IMPROVEMENTS

CITY

42 SHEET: XX JOB NO.: 13570 DWG: CHANNELIZATION





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CONTRACTOR SHALL REMOVE AND WASTE HAUL EXISTING SIGN POST AND FOUNDATION AND DELIVER SIGN TO CITY OF ISSAQUAH PUBLIC WORKS DEPARTMENT.

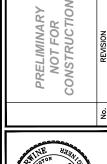


- 1. ALL SIGN TYPES, COLORS, AND DIMENSIONS ARE STANDARD PER THE MUTCD, UNLESS OTHERWISE INDICATED.

- 5. CONTRACTOR SHALL FURNISH AND INSTALL TWO-WAY LEFT TURN LINE PER CITY OF ISSAQUAH STANDARD DETAIL T-19.
- 6. CONTRACTOR SHALL FURNISH AND INSTALL 6" WHITE METHYL METHACRYLATE FOG LINE PER CITY OF ISSAQUAH STANDARD DETAIL T-23.
- 8. CONTRACTOR SHALL FURNISH AND INSTALL BICYCLE LANE SYMBOLS PER CITY OF ISSAQUAH STANDARD DETAIL T-27.
- 9. CONTRACTOR SHALL FURNISH AND INSTALL SHARROW BICYCLE
 LANE SYMBOLS PER CITY OF ISSAQUAH STANDARD DETAIL
 T-28.
- 11. CONTRACTOR SHALL FURNISH AND INSTALL TYPE A CURBING PER CITY OF ISSAQUAH STANDARD DETAIL T—39.
- 12. CONTRACTOR SHALL FURNISH AND INSTALL VERTICAL CONCRETE CURB PER CITY OF ISSAQUAH STANDARD DETAIL T-38.



- CONTRACTOR SHALL FURNISH AND INSTALL NEW SIGN AND POST PER CITY OF ISSAQUAH STANDARD DETAIL T-44.



SCALE: H:

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ISSAQUAH WASHINGTO

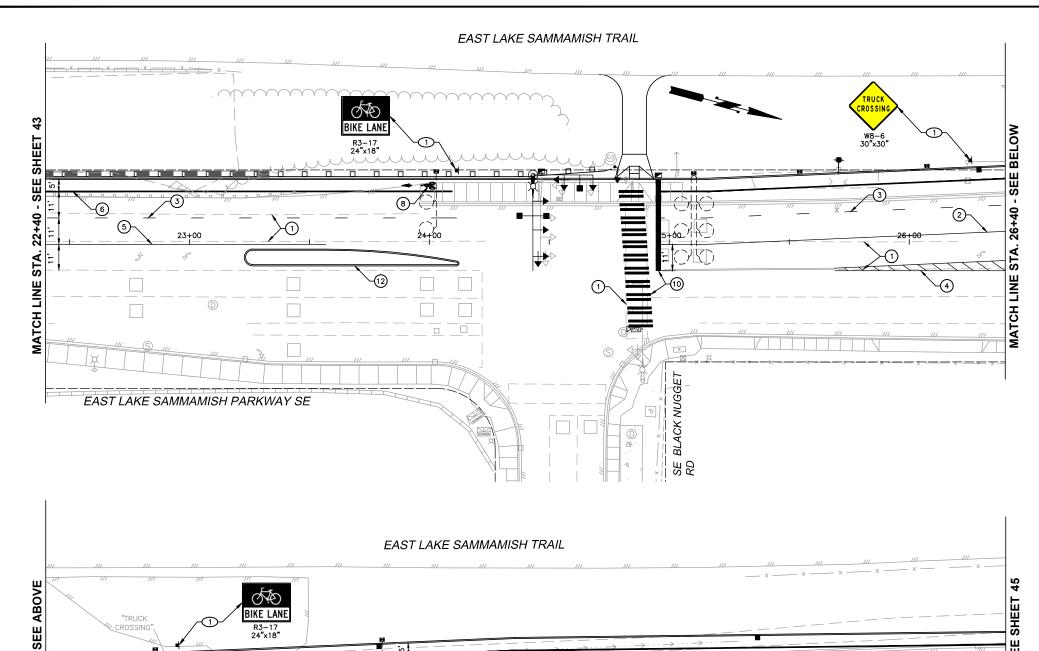
OF

CITY

SAMMAMISH PARKWAY

EAST LAKE 43 SHEET: XX

JOB NO.: 13570 DWG: CHANNELIZATION





GENERAL

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CONTRACTOR SHALL REMOVE AND WASTE HAUL EXISTING SIGN POST AND FOUNDATION AND DELIVER SIGN TO CITY OF ISSAQUAH PUBLIC WORKS DEPARTMENT.



JAN.

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|------------|------------|----------|-----------|
| 1"=20 | αġ | C.B.W. | B.L.S. |
| <u>"</u> " | B.J.B. | | |
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PRELIMINARY NOT FOR CONSTRUCTION NO1 CONSTI





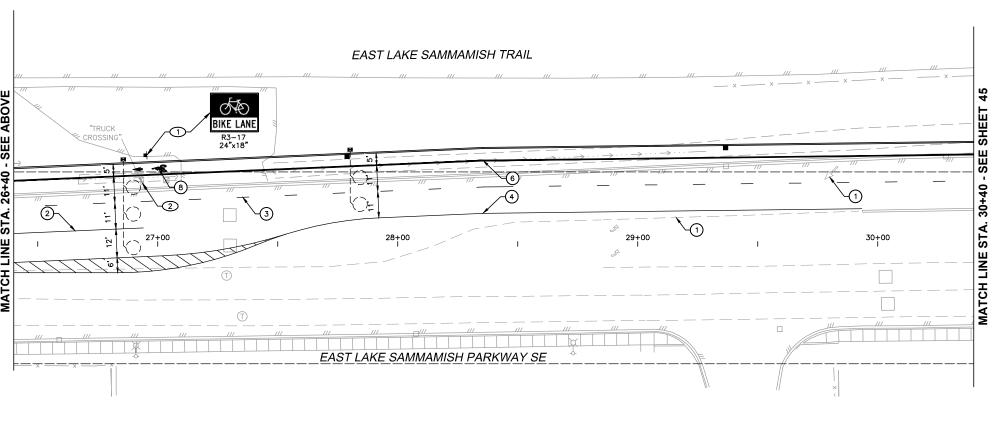
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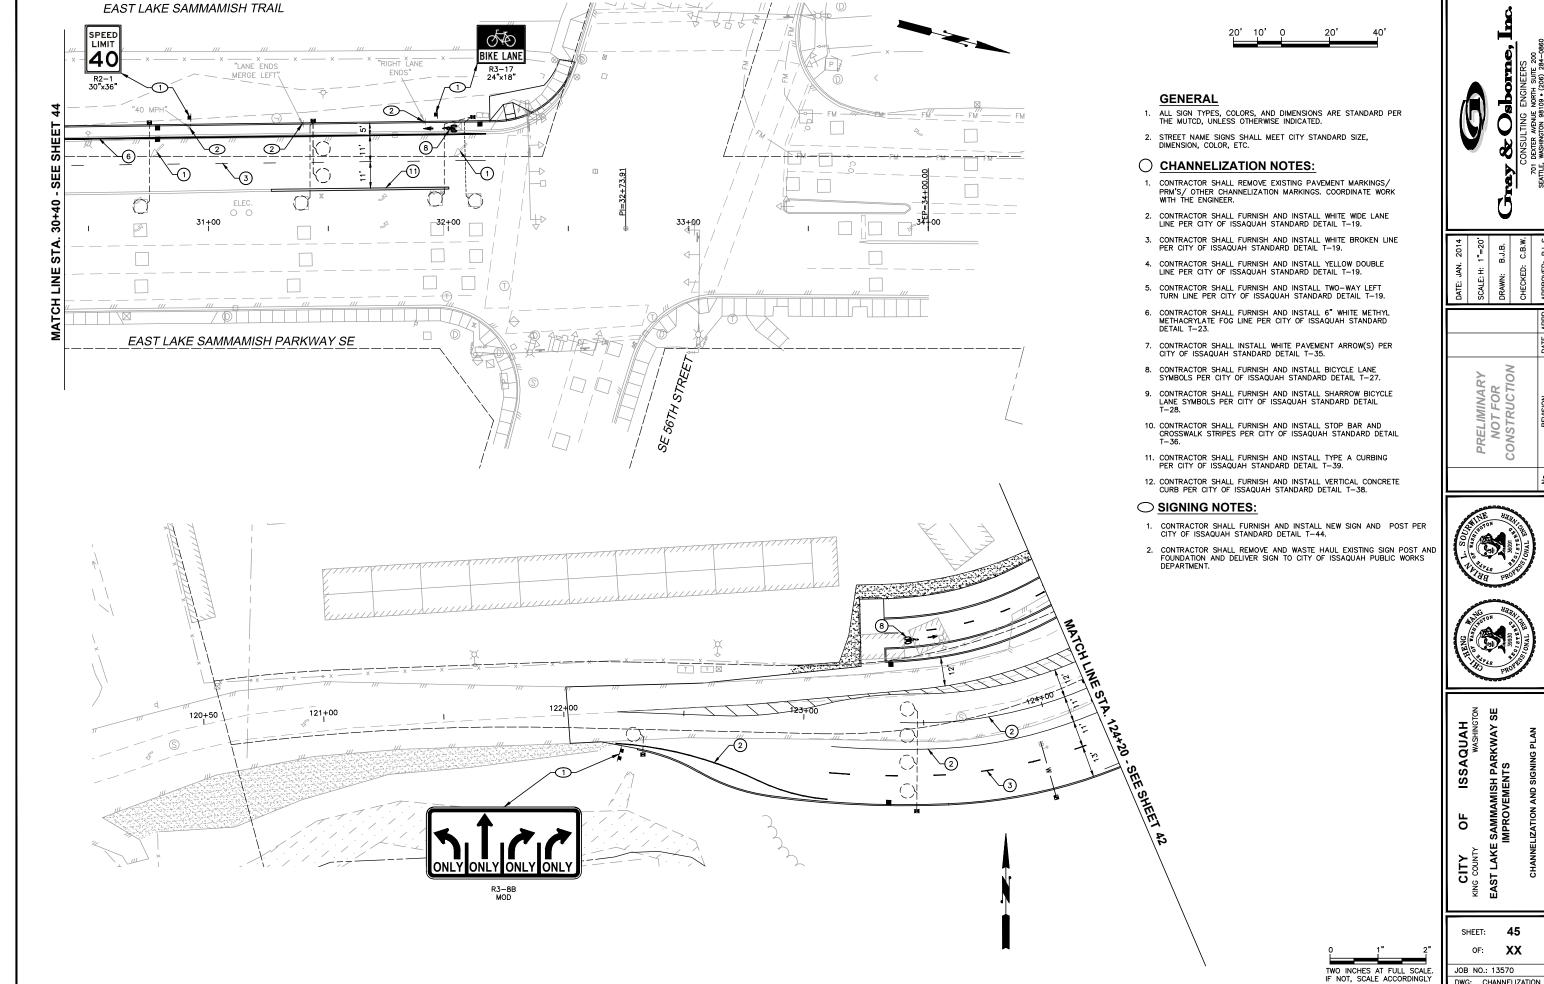
ISSAQUAH WASHINGTO

SAMMAMISH PARKWAY OF LAKE CITY

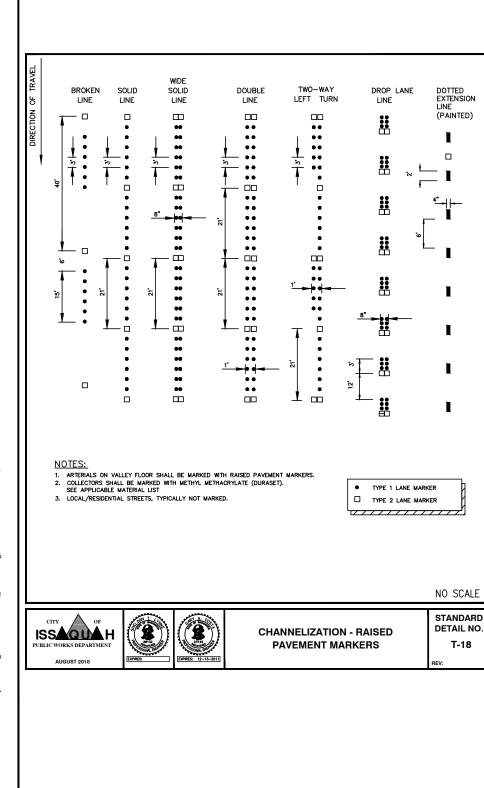
EAST I 44 SHEET: XX

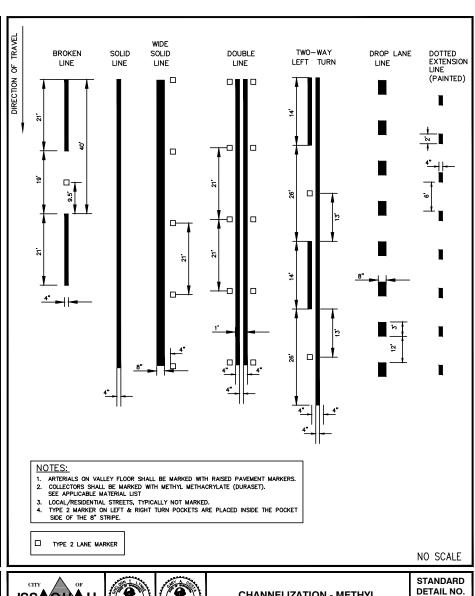
JOB NO.: 13570 DWG: CHANNELIZATION





NSSAQUAH/13570 E. Lake Sammamish Pkwy/01 Design/Planset/CHANNELIZATION.dwg, 1/22/2014 3:42:37 PM, bbollen






CHANNELIZATION - METHYL

METHACRYLATE MARKINGS

ISSAQUA H

T-19

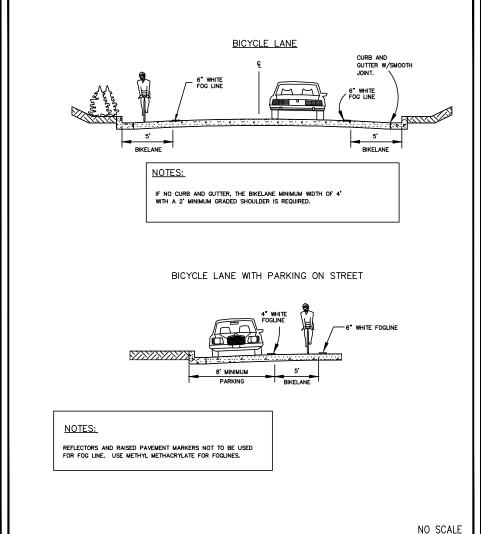ISSAQUA H



BICYCLE LANES AND

ON STREET PARKING



PRELIMINARY NOT FOR CONSTRUCTION

STANDARD DETAIL NO. T-23

ISSAQUAH WASHINGTO

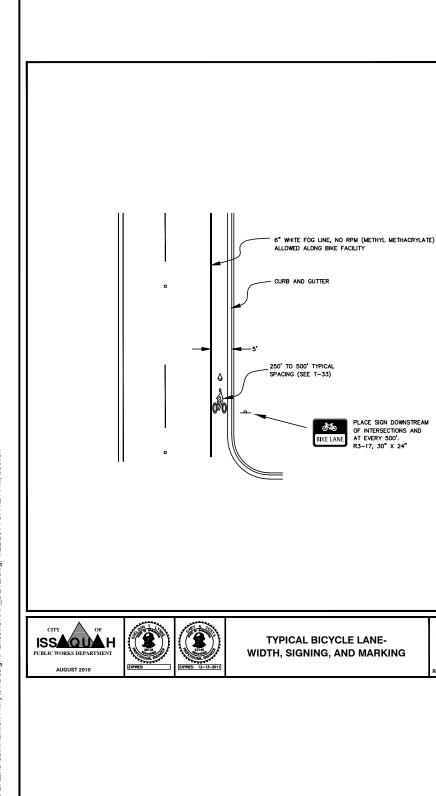
SAMMAMISH PARKWAY SE IMPROVEMENTS OF

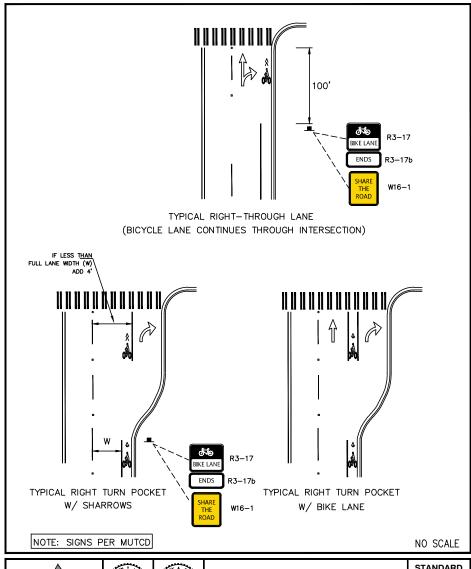
CHANNELIZATION AND SIGNING DETAILS

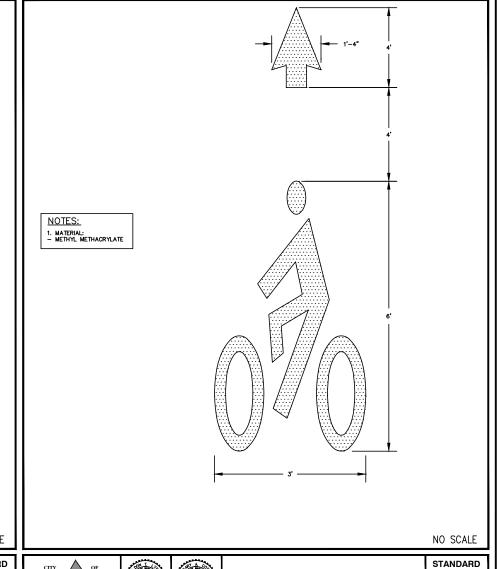
EAST LAKE CITY NG COUNTY

46 SHEET: XX OF: JOB NO.: 13570 CHAN_DET1 DWG:












PRELIMINARY NOT FOR CONSTRUCTION



ISSAQUAH WASHINGTON

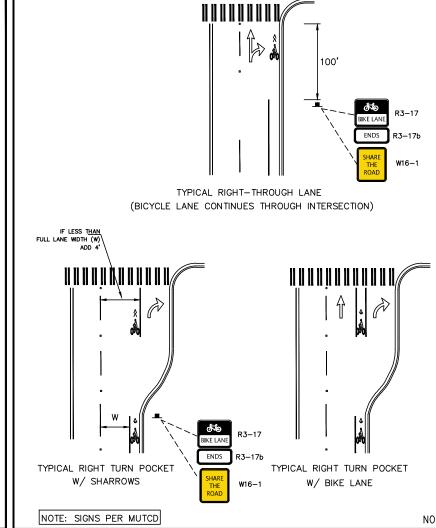EAST LAKE SAMMAMISH PARKWAY SE IMPROVEMENTS ОЕ



WIDTH, SIGNING, AND MARKING

STANDARD DETAIL NO. T-24

NO SCALE









DETAIL NO. T-25

STANDARD ISSAGUA H
PUBLIC WORKS DEPARTMENT

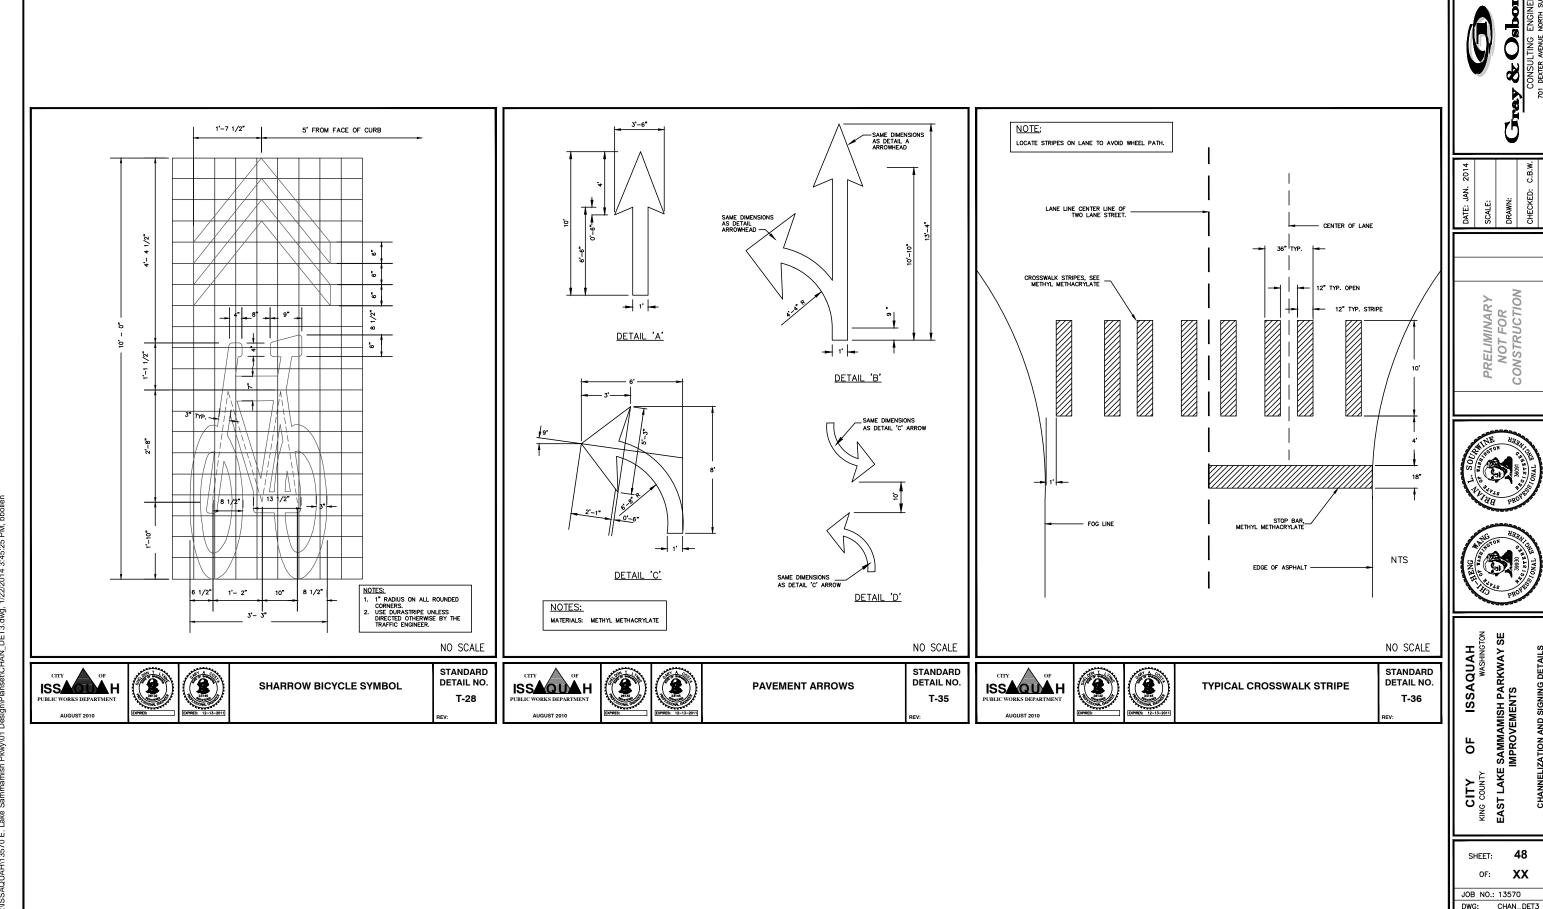


BICYCLE LANE MARKINGS

DETAIL NO. T-27

CITY KING COUNTY


SHEET: XX JOB NO.: 13570 DWG: CHAN_DET2




EAST LAKE SAMMAMISH PARKWAY SE IMPROVEMENTS

XX

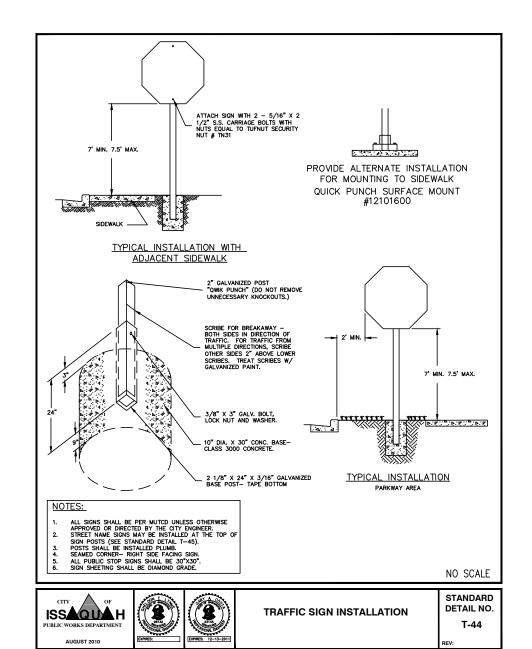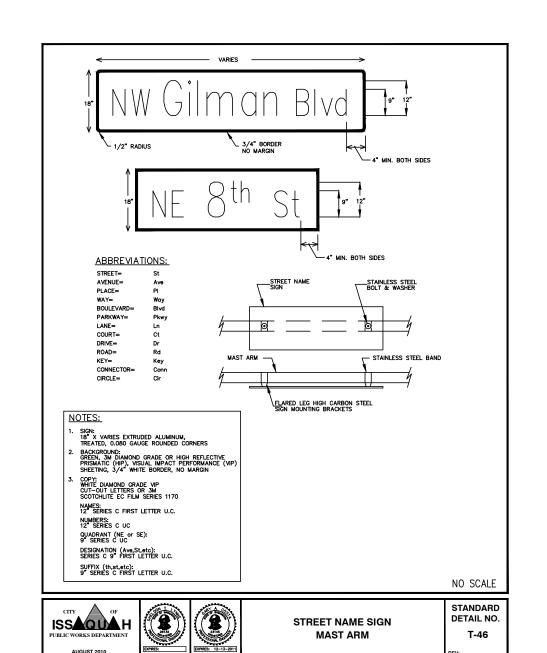CHANNELIZATION AND SIGNING DETAILS








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PRELIMINARY NOT FOR CONSTRUCTION

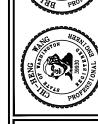

ISSAQUAH WASHINGTON SAMMAMISH PARKWAY SE IMPROVEMENTS

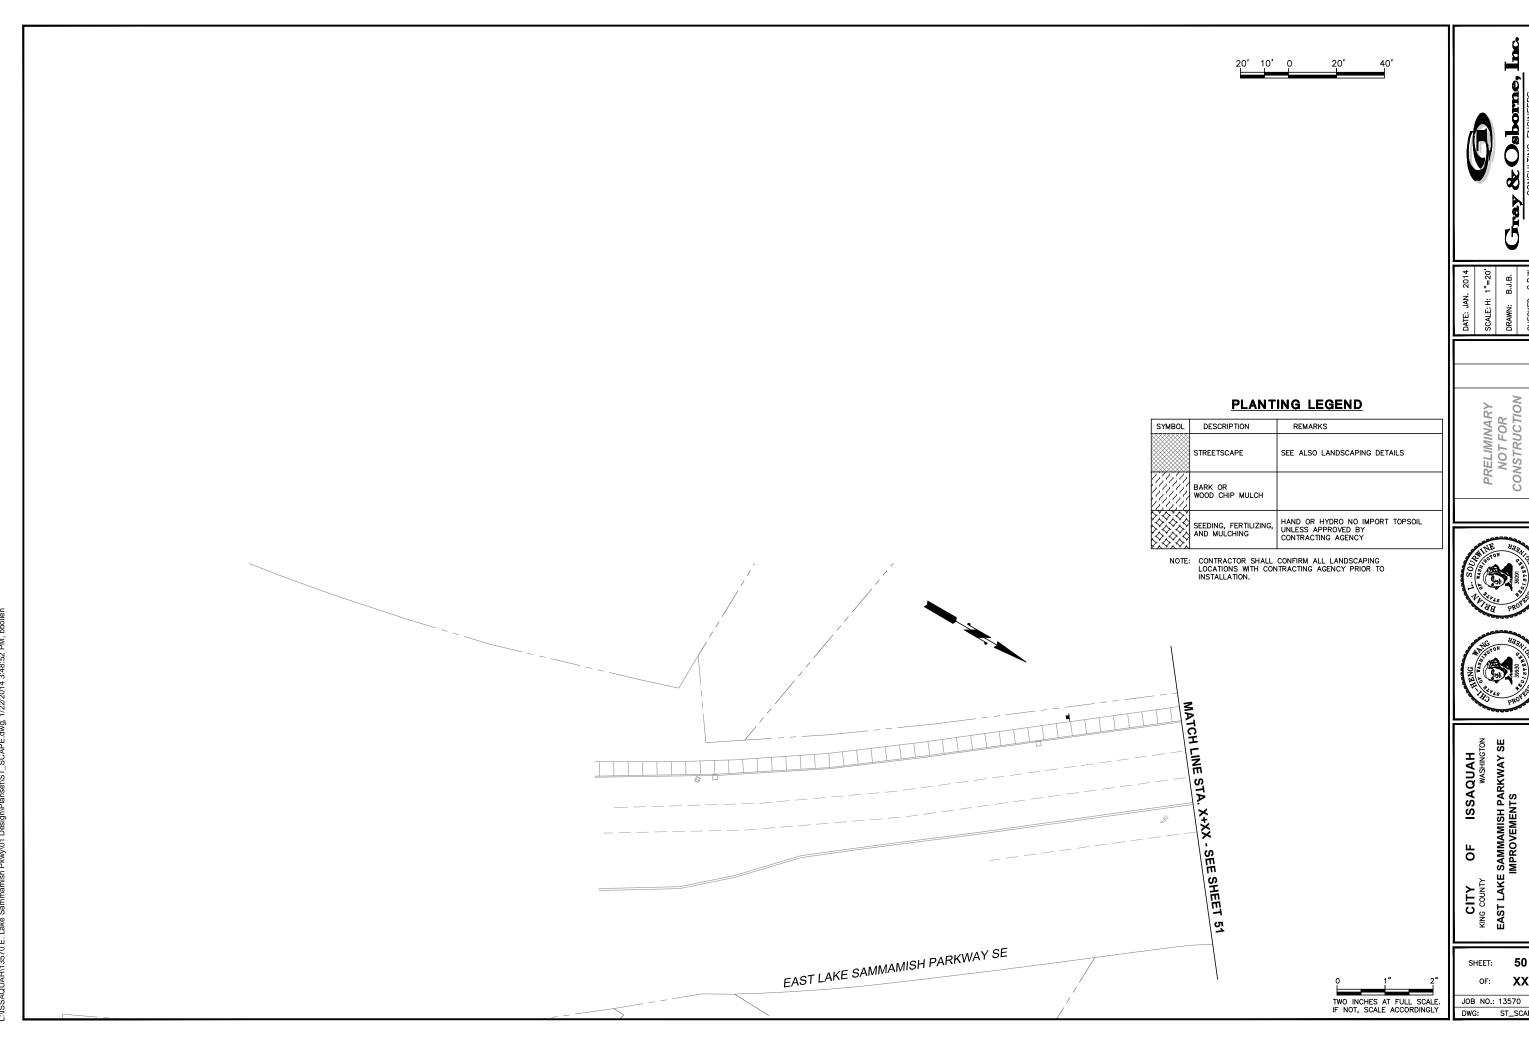
О

EAST LAKE CITY KING COUNTY

49 SHEET: XX OF: JOB NO.: 13570

DWG: CHAN DET4

CHANNELIZATION AND SIGNING DETAILS




DATE: JAN. 2014
SCALE: H: 1"=20'
DRAWN: B.J.B.
CHECKED: C.B.W.
APPROVED: B.L.S.



EAST LAKE SAMMAMISH PARKWAY SE IMPROVEMENTS ROADSIDE PLANTING PLAN

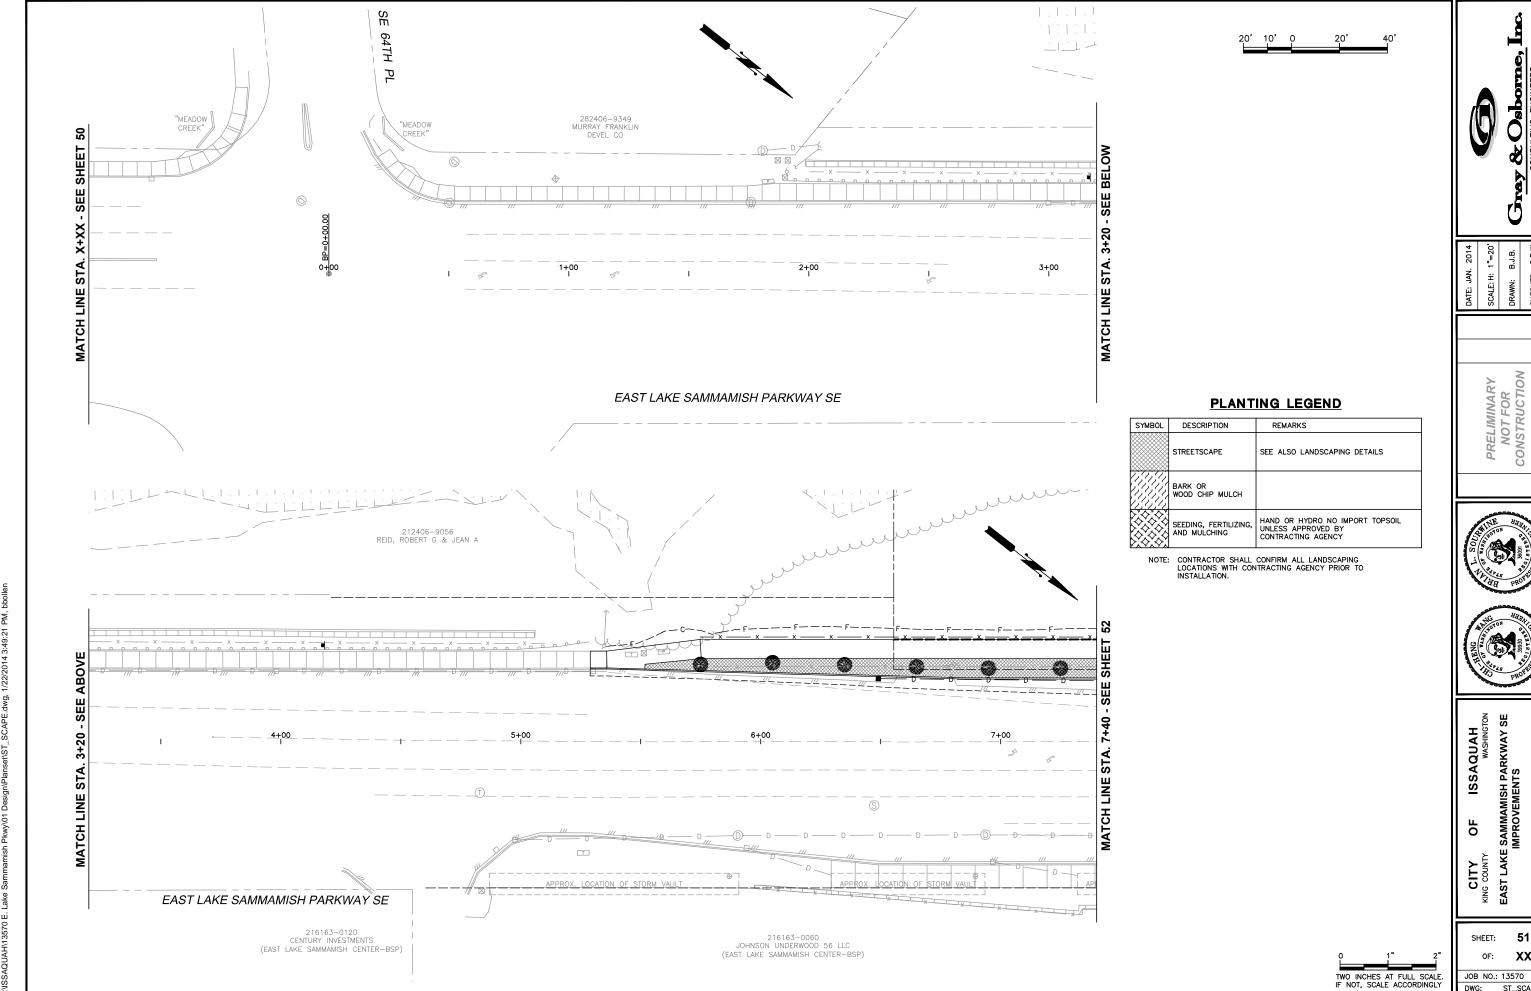
50 XX JOB NO.: 13570 ST_SCAPE



51

XX

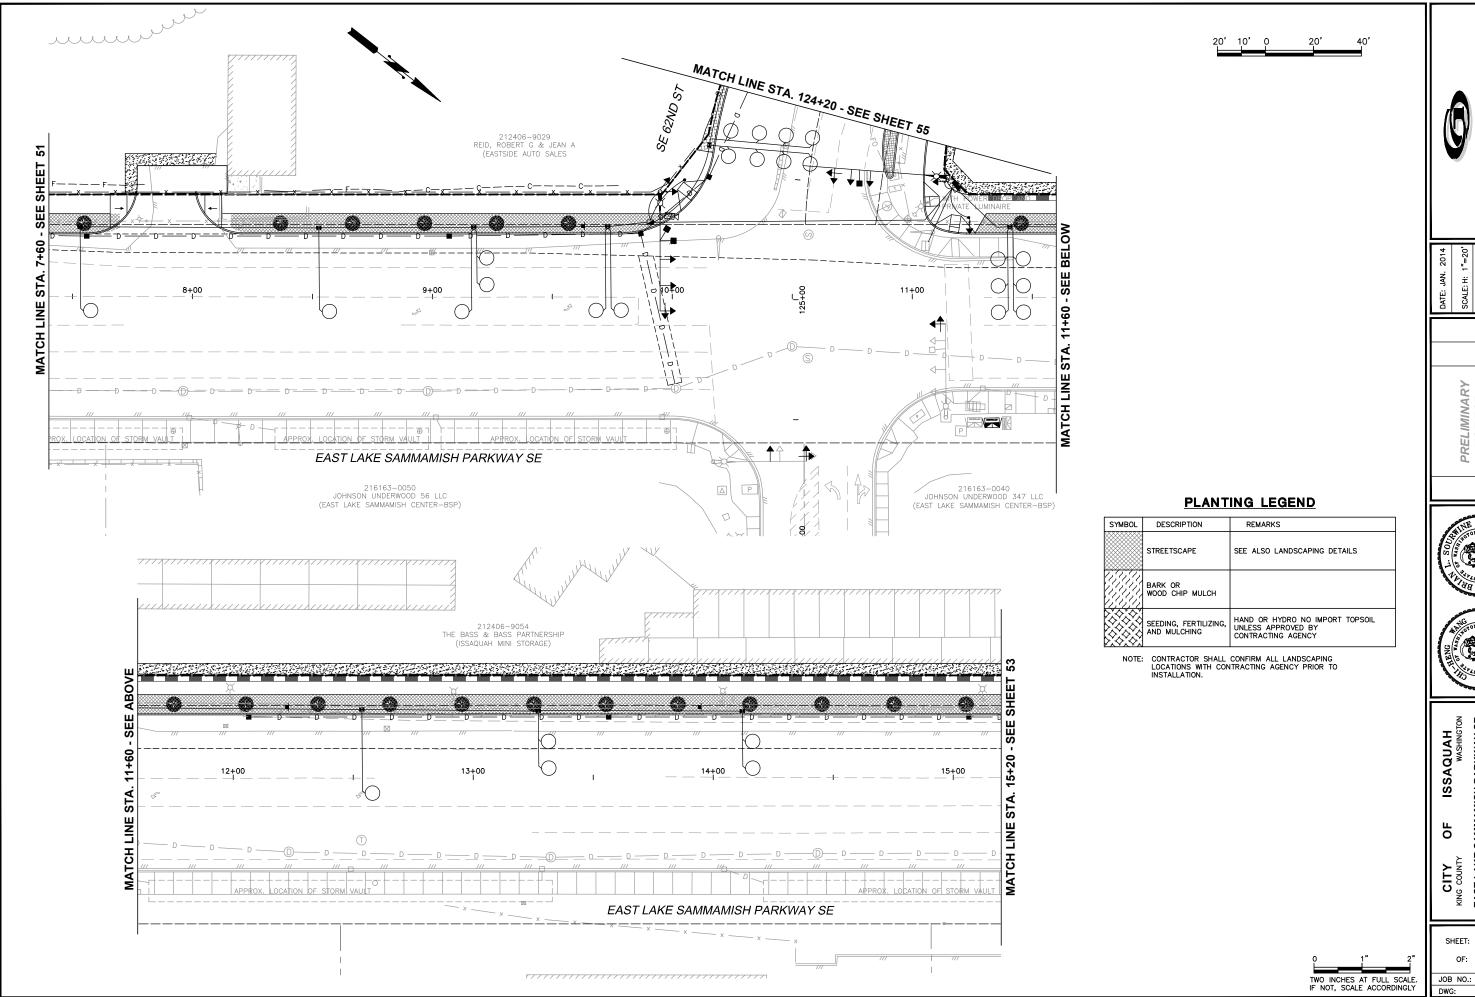ST SCAPE



SCALE: H:
DRAWN: E
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PRELIMINARY NOT FOR CONSTRUCTION

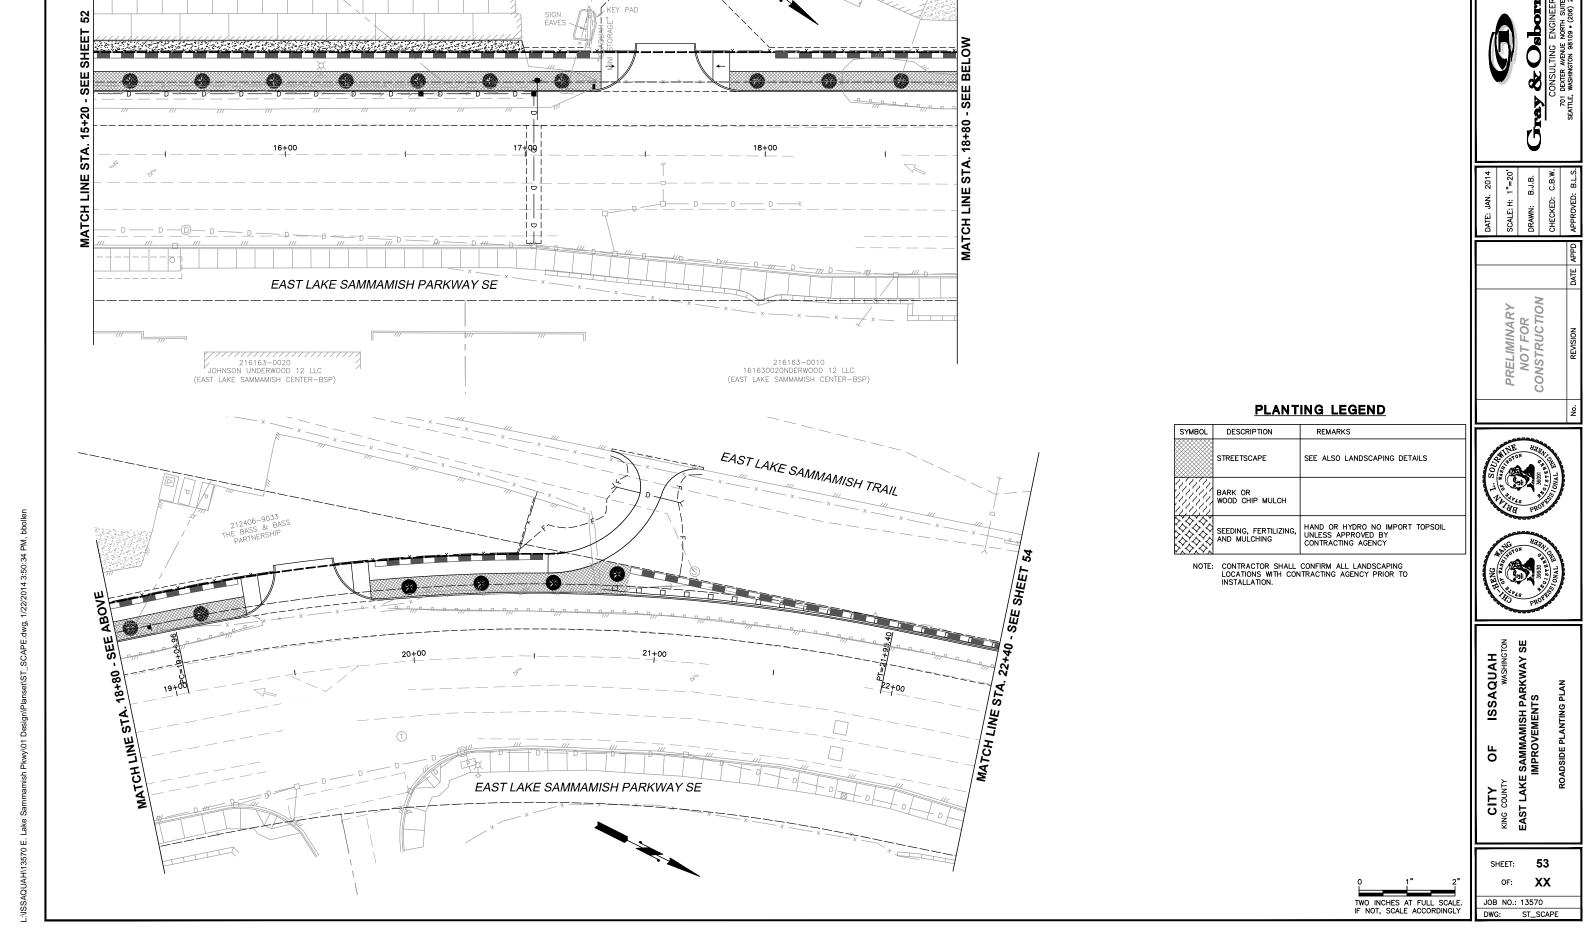


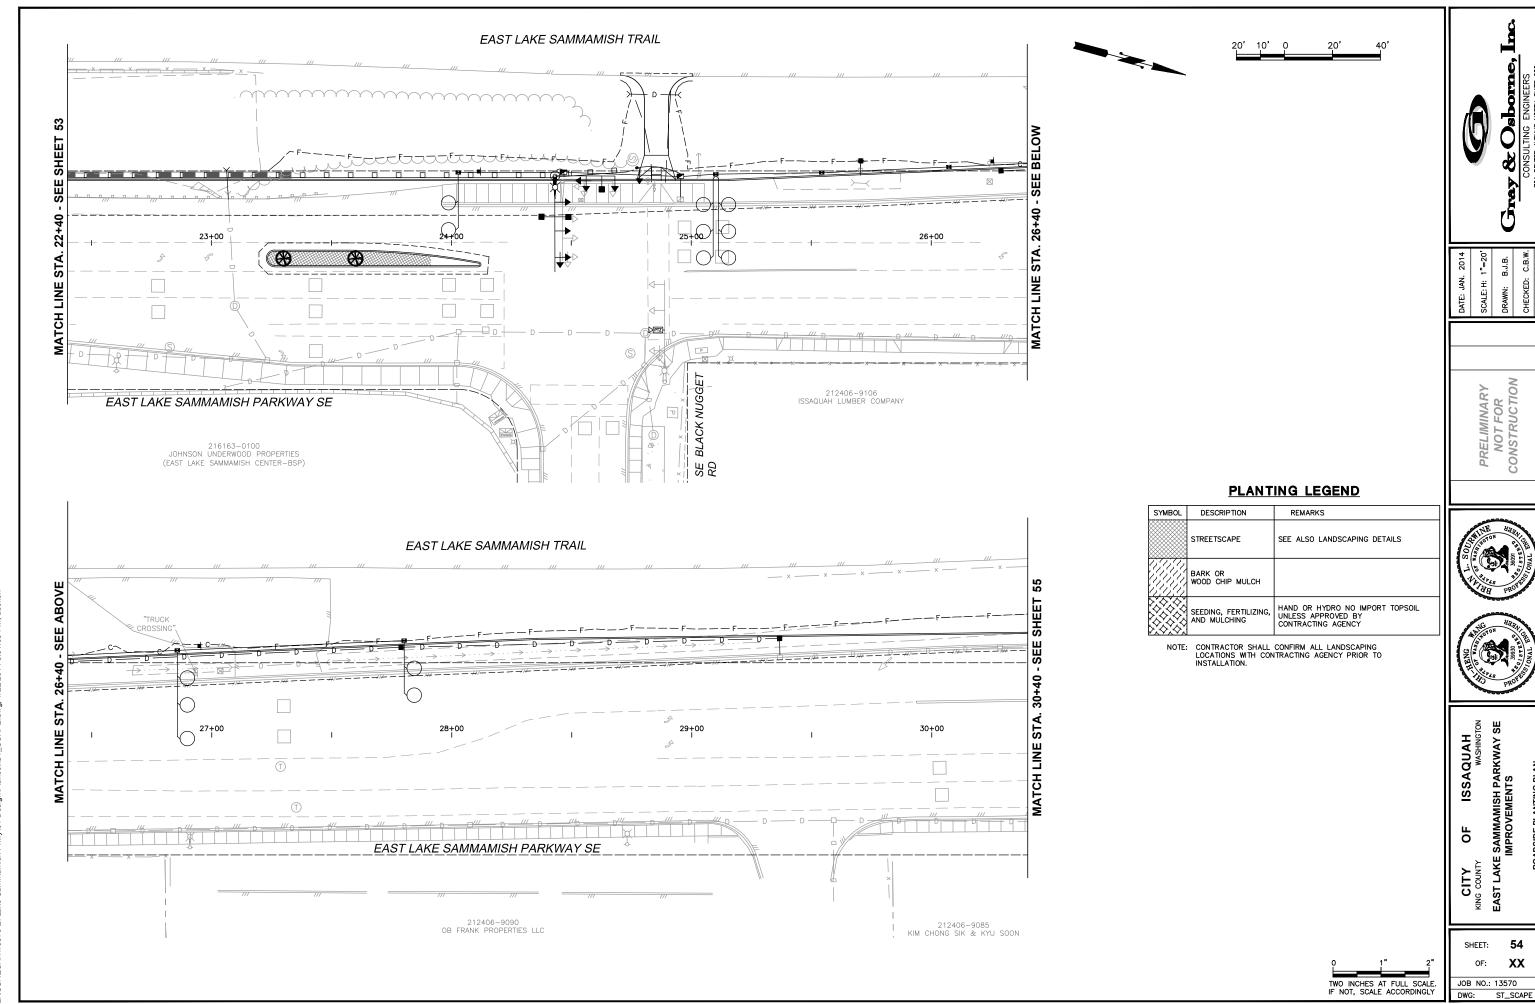


EAST LAKE SAMMAMISH PARKWAY SE IMPROVEMENTS

52

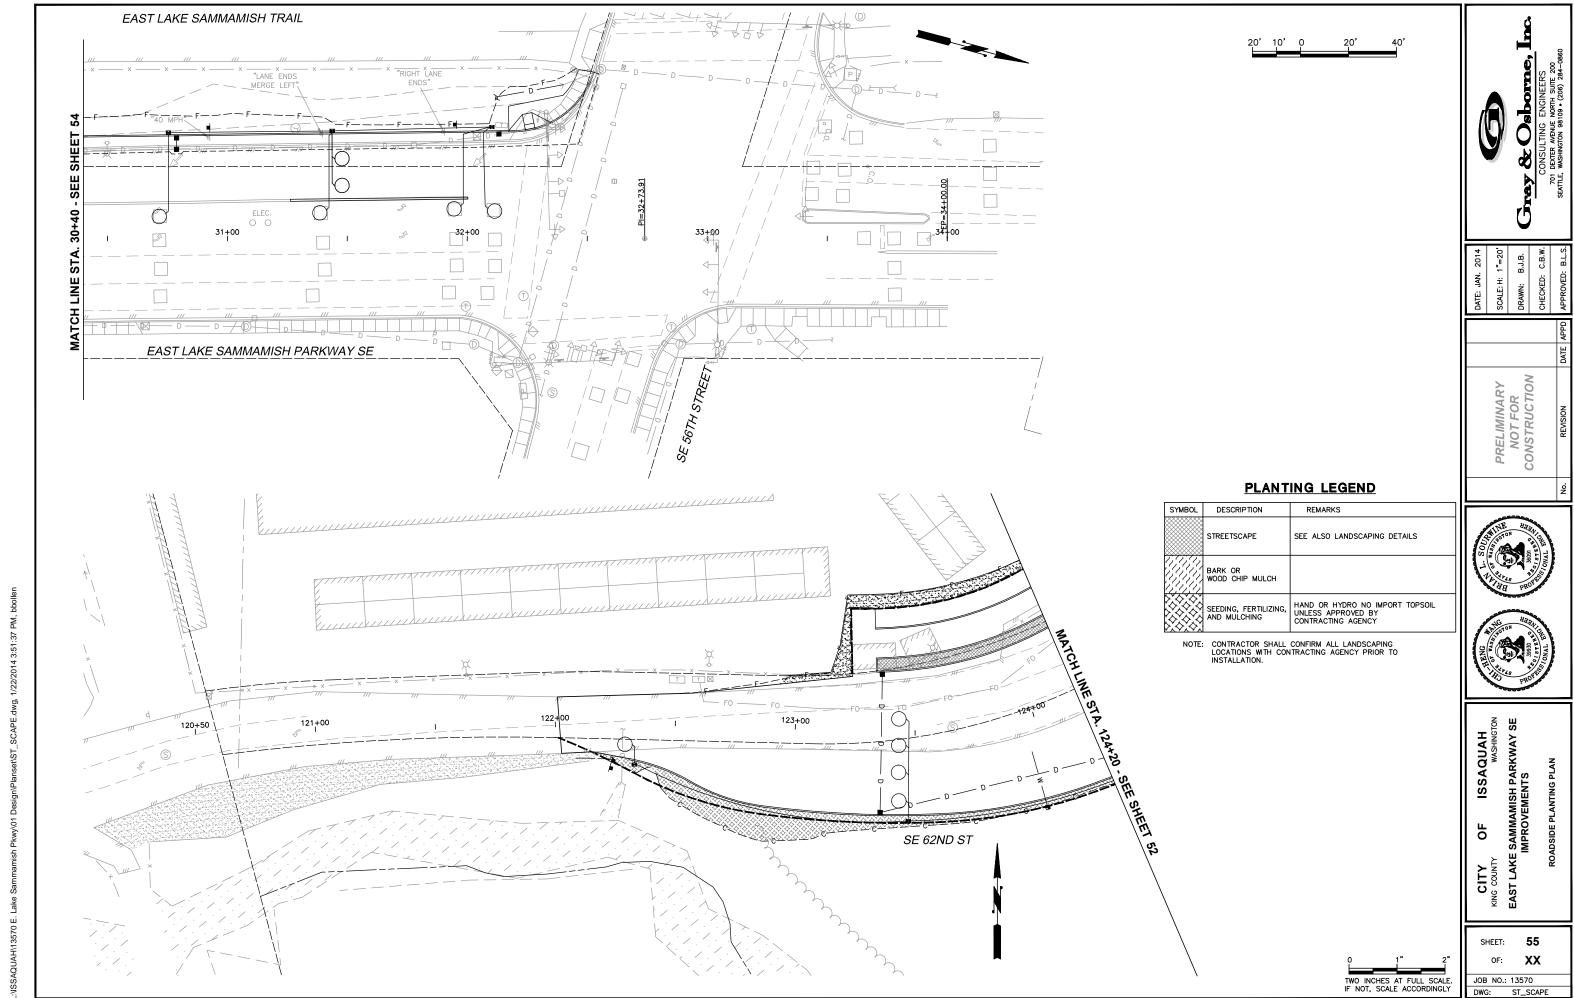
XX JOB NO.: 13570 ST SCAPE



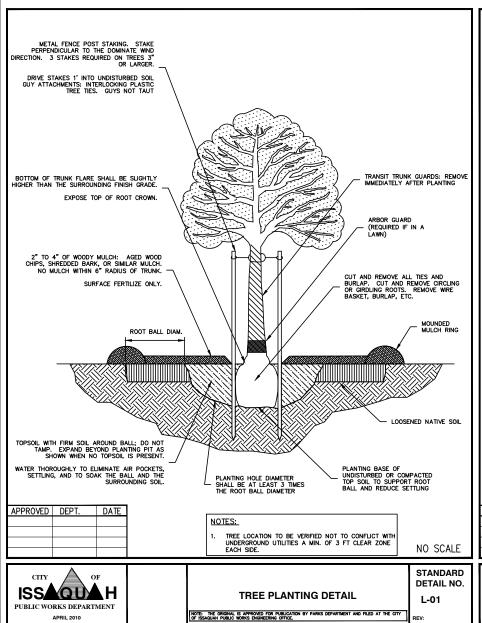


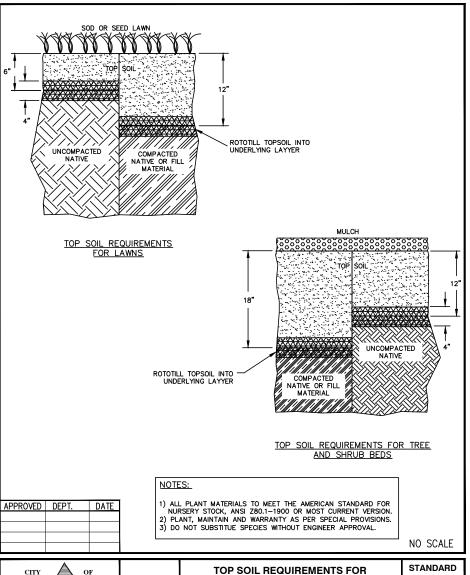
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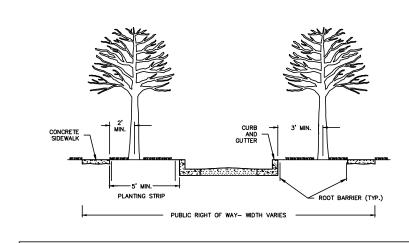




ISSAQUA H

PUBLIC WORKS DEPARTMENT

APRIL 2010



NOTES:

1. TREE SPACING IS DEPENDANT ON THE SIZE AND TYPE OF STREET TREE USED. SEE CONTRACT FOR SPACING.

1. TREES SHALL NOT BE PLACED IN SIGHT DISTANCE TRIANGLES PER MOST CURRENT VERSION OF AMERICAN ASSOCIATION OF STATE HIGHWAY AND TRANSPORTATION OFFICIALS (AASHTO) OR CITY STANDARDS.

3. COORDINATE WITH INFAFFIC SIGNAL REGINEERS OF INFAT TIRES DO NOT OBSTRUCT OPERATIONS OF TRAFFIC SIGNAL SYSTEMS.

4. PLANTING STRIP IRRIGATION SYSTEMS SHALL MEET IRRIGATION STANDARD AND INCORPORATE LATEST WATER CONSERVATION TECHNIQUES.

5. STREET TREES SHALL HAVE A MINIMUM OVERHEAD CLEARANCE OF SEVEN (7) FEET OVER PEDESTRIAN PATHWAYS AND FOURTEEN (14) FEET OVER STREETS. STREET TREES SHALL BE CENTERED A MINIMUM OF PETIF FROM SITERES CONS. TWENTY (20) FEET FROM STREET LIGHTS, THREE (3) FEET FROM CURBS AND TWO (2) FEET FROM SIDEWALKS OR AS OTHERWISE APPROVED BY THE CITY.

6. STREET TREES SHALL BE PLANTED IN A PLANTING STRIP WITH A MINIMUM OF FIVE (5) FEET BETWEEN THE SIDEWALK AND THE BACK OF THE CURB

7. TREE PIT AREA SHALL BE A MINIMUM OF 24 SQUARE FEET.

8. ROOT BARRIER SHALL EXTEND A MINIMUM OF 5 FEET BEYOND TREE (REFER TO MANUFACTURERS DETAIL).

APPROVED DEPT. DATE

NO SCALE

COMPACTED AND NON-COMPACTED SOILS

NOTE: THE ORIGINAL IS APPROVED FOR PUBLICATION BY PARKS DEPARTMENT AND FILED AT THE CITY OF ISSAGUAN PUBLIC WORKS ENGINEERING OFFICE. L-02

DETAIL NO.

TYPICAL STREET TREE LOCATION REQUIREMENTS

NOTE: THE ORIGINAL IS APPROVED FOR PUBLICATION BY PARKS DEPARTMENT AND FILED AT THE CITY OF ISSACIJAH PUBLIC WORKS ENGINEERING OFFICE.

OF

EAST LAKE CITY NG COUNT

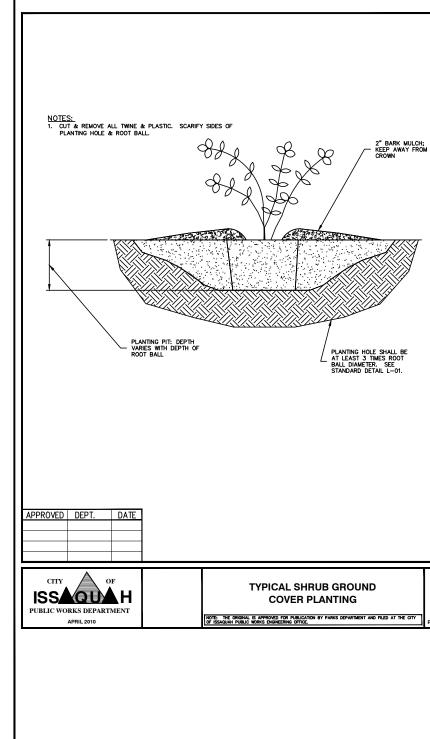
56 SHEET: XX OF: JOB NO.: 13570 DWG: LAND DET1

ISS QUAH PUBLIC WORKS DEPARTMENT APRIL 2010

STANDARD DETAIL NO. L-03

PRELIMINARY NOT FOR CONSTRUCTION SE ISSAQUAH WASHINGTO SAMMAMISH PARKWAY

DRAWN:



NO SCALE

STANDARD


DETAIL NO.

L-04


ISS QUAH

PUBLIC WORKS DEPARTMENT

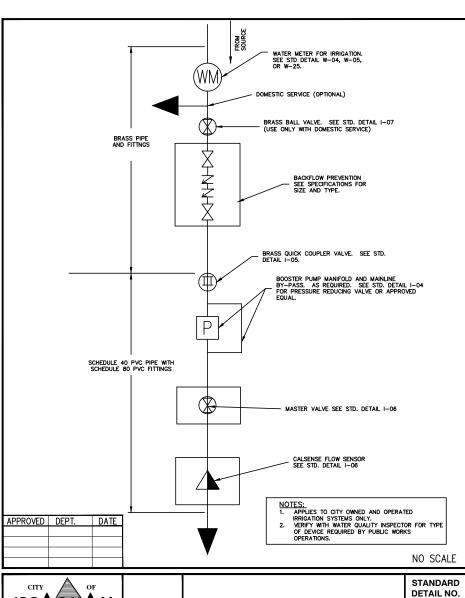APRIL 2010



IRRIGATION CONNECTION SCHEMATIC

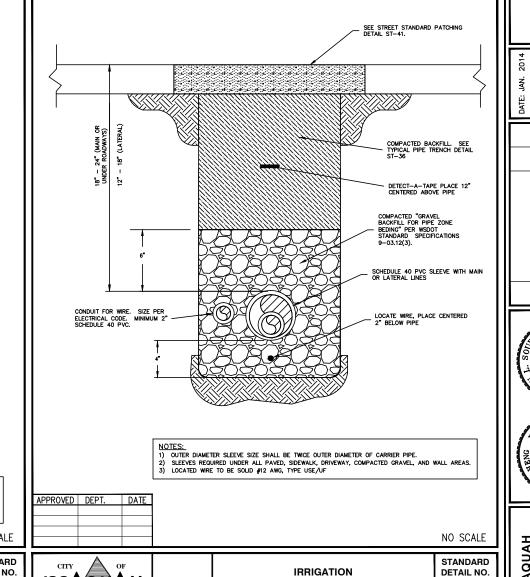

SLEEVE TRENCHING

ISS QUAH

PUBLIC WORKS DEPARTMENT

APRIL 2010

I-01

ISSAQUAH WASHINGTON

I-02

SAMMAMISH PARKWAY SE IMPROVEMENTS О EAST LAKE CITY KING COUNTY

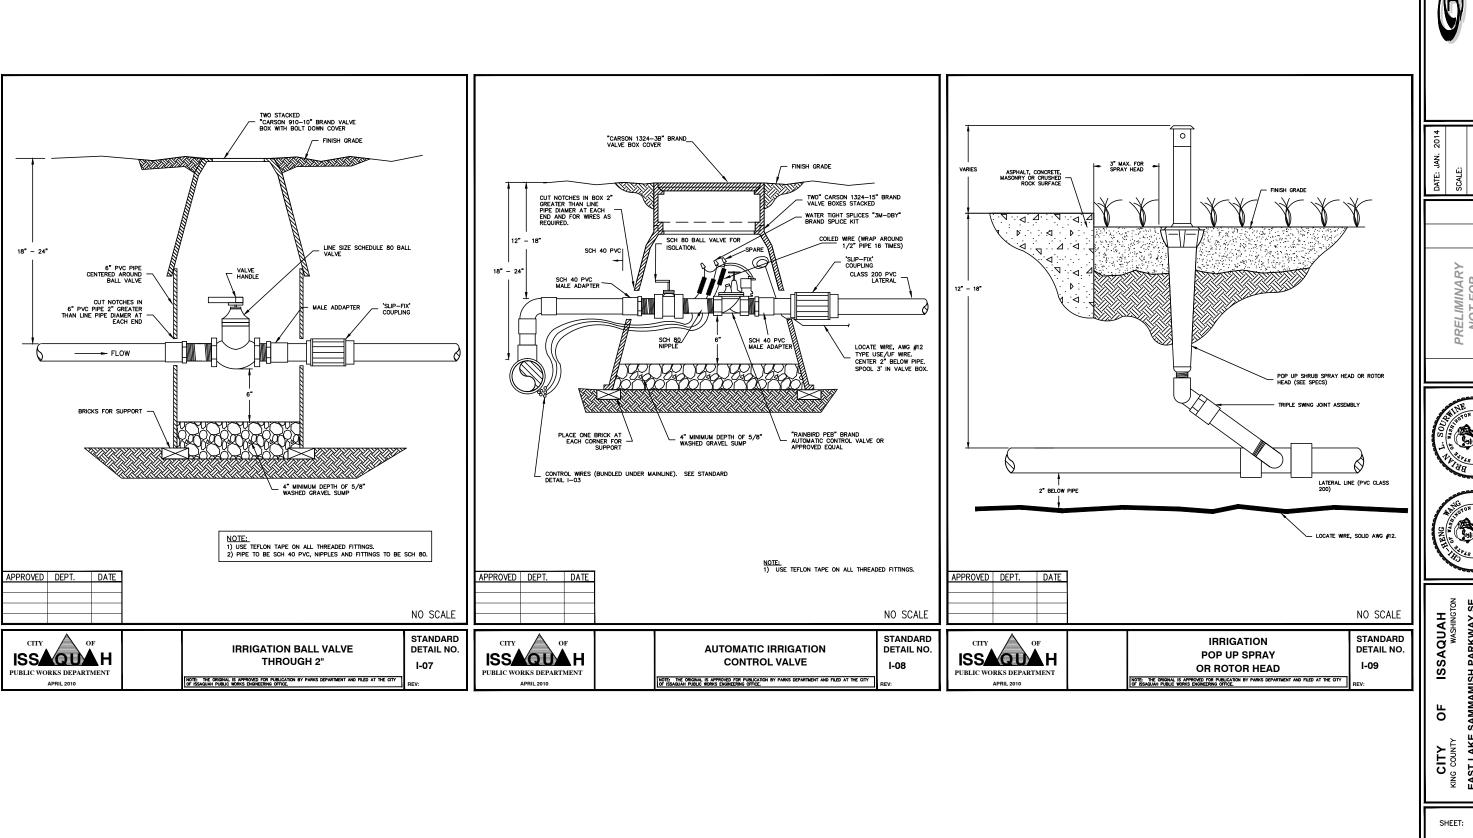
PLANTING AND LANDSCAPE DETAILS

PRELIMINARY NOT FOR CONSTRUCTION

57 SHEET: XX OF: JOB NO.: 13570

DWG: LAND_DET2



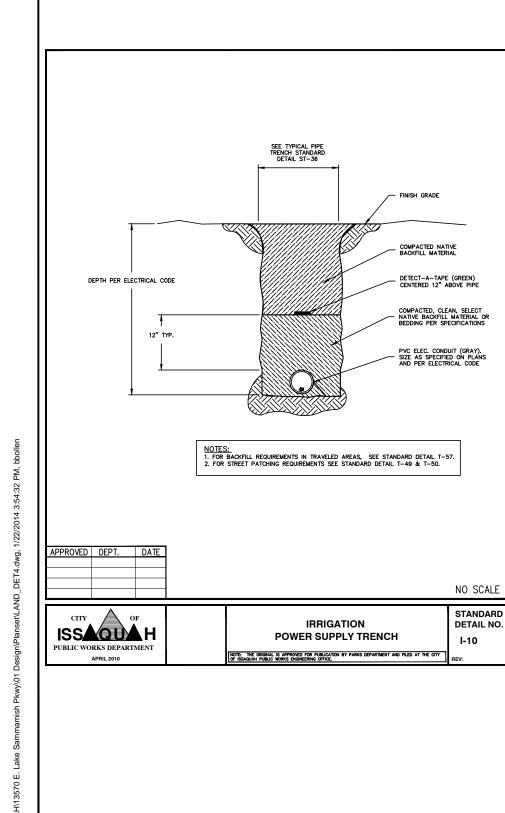


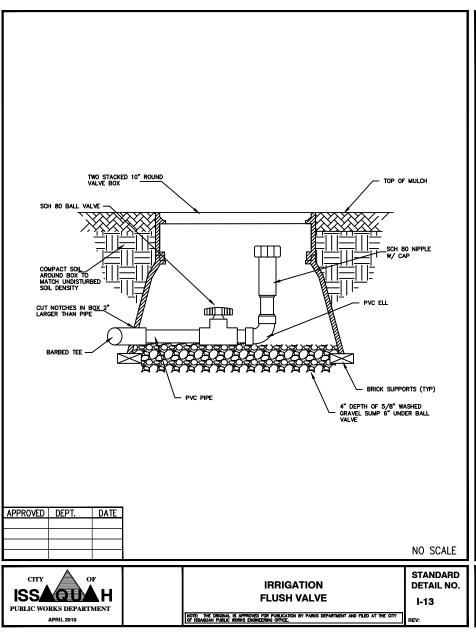
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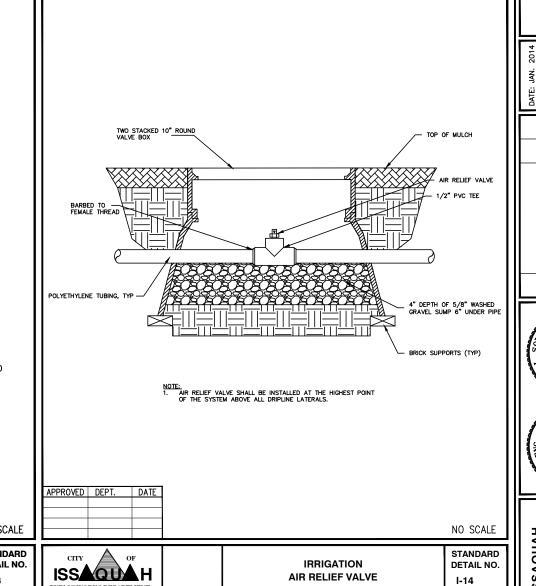
SAMMAMISH PARKWAY SE IMPROVEMENTS EAST LAKE

58 XX OF: JOB NO.: 13570

DWG: LAND DET3







NOTE: THE ORIGINAL IS APPROVED FOR PUBLICATION BY PARKS DEPARTMENT AND FILED AT THE CITY OF ISSAQUAH PUBLIC WORKS ENGINEERING OFFICE.

PUBLIC WORKS DEPARTMENT

APRIL 2010



PRELIMINARY NOT FOR CONSTRUCTION

ISSAQUAH WASHINGTON

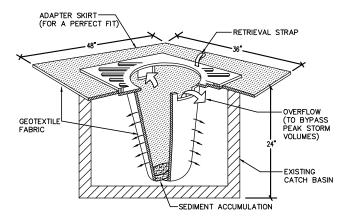
EAST LAKE SAMMAMISH PARKWAY SE IMPROVEMENTS Ы CITY KING COUNTY

PLANTING AND LANDSCAPE DETAILS


59 SHEET: XX OF: JOB NO.: 13570 DWG: LAND_DET4

EROSION/SEDIMENTATION CONTROL NOTES

- 1. CONTRACTOR SHALL SUBMIT TEMPORARY WATER POLLUTION/EROSION CONTROL PLAN PER THE CONTRACT SPECIFICATIONS.
- 2. ALL LIMITS OF CLEARING AND AREAS OF VEGETATION PRESERVATION SHALL BE OBSERVED
- ALL REQUIRED SEDIMENTATION/EROSION CONTROL FACILITIES MUST BE IN OPERATION PRIOR TO LAND CLEARING AND/OR OTHER CONSTRUCTION TO ENSURE THAT SEDIMENT LADEN WATER DOES NOT ENTER THE NATURAL DRAINAGE SYSTEM. ALL EROSION AND SEDIMENT FACILITIES SHALL BE MAINTAINED IN A SATISFACTORY CONDITION UNTIL SUCH TIME THAT CLEARING AND /OR CONSTRUCTION IS COMPLETED AND THE POTENTIAL FOR ON-SITE EROSION HAS PASSED. THE IMPLEMENTATION, MAINTENANCE, REPLACEMENT AND ADDITIONS TO EROSION/SEDIMENTATION CONTROL SYSTEMS SHALL BE THE RESPONSIBILITY OF THE CONTRACTOR.
- 4. THE EROSION AND SEDIMENTATION CONTROL SYSTEMS DEPICTED ON THIS DRAWING ARE INTENDED TO BE MINIMUM REQUIREMENTS TO MEET ANTICIPATED SITE CONDITIONS. AS CONSTRUCTION PROGRESSES AND AS UNEXPECTED OR SEASONAL CONDITIONS DICTATE, THE CONTRACTOR SHOULD ANTICIPATE THAT MORE EROSION AND SEDIMENTATION CONTROL CUNITACTION SHOULD ANTICIPATE THAT MORE ENOSION AND SEDIMENTATION CONTROL FACILITIES WILL BE NECESSARY TO ENSURE COMPLETE SILTATION CONTROL ON THE PROPOSED SITE. DURING THE COURSE OF CONSTRUCTION, IT SHALL BE THE OBLIGATION AND RESPONSIBILITY OF THE CONTRACTOR TO ADDRESS ANY NEW CONDITIONS THAT MAY BE CREATED BY HIS ACTIVITIES AND TO PROVIDE ADDITIONAL FACILITIES, OVER AND ABOVE THE MINIMUM REQUIREMENTS, AS MAY BE NEEDED TO PROTECT ADJACENT PROPERTIES AND THE WATER QUALITY OF THE RECEIVING DRAINAGE SYSTEM.
- AT NO TIME SHALL MORE THAN ONE FOOT OF SEDIMENT BE ALLOWED TO ACCUMULATE WITHIN A CATCH BASIN. THE CONTRACTOR SHALL BE RESPONSIBLE FOR REMOVING AND DISPOSING OF THE SEDIMENT. ALL CATCH BASINS, CONVEYANCE LINES AND DITCHES SHALL BE CLEANED PRIOR
- 6. THE CONTRACTOR SHALL REMOVE MATERIAL DROPPED, WASHED OR TRACKED FROM VEHICLES ONTO THE TOWN RIGHT-OF-WAY OR INTO THE EXISTING STORM DRAINAGE SYSTEM. DEBRIS SHALL NOT BE WASHED INTO THE STORM DRAINAGE SYSTEM.
- 7. TEMPORARY EROSION CONTROL FACILITIES SHALL BE INSPECTED WEEKLY AND MAINTAINED WITHIN 24 HOURS FOLLOWING A STORM EVENT. SEDIMENT SHALL BE REMOVED TO INSURE THE FACILITIES WILL FUNCTION PROPERLY. THE FACILITIES SHALL BE SATISFACTORILY MAINTAINED UNTIL CONSTRUCTION IS COMPLETED AND THE POTENTIAL FOR ON—SITE EROSION HAS PASSED.
- ALL STORM DRAIN INLETS MADE OPERABLE DURING CONSTRUCTION SHALL BE PROTECTED SO THAT STORMWATER RUNOFF SHALL NOT ENTER THE CONVEYANCE SYSTEM WITHOUT FIRST BEING FILTERED OR OTHERWISE TREATED TO REMOVE SEDIMENT.
- 9. NO DISTURBED SOIL SHALL REMAIN UNSTABILIZED FOR MORE THAN TWO DAYS.
- 10. CONTRACTOR SHALL CONFORM TO THE D.O.E. STORMWATER GENERAL PERMIT CONDITIONS.



STORM DRAIN INLET PROTECTION

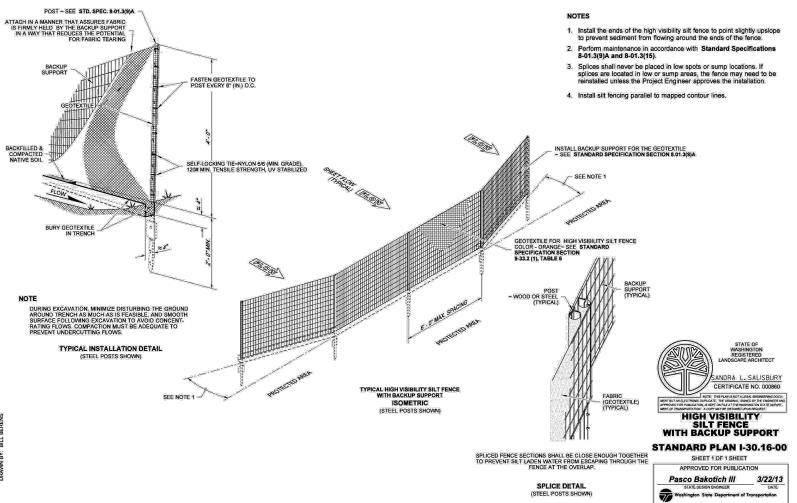





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PRELIMINARY NOT FOR CONSTRUCTION

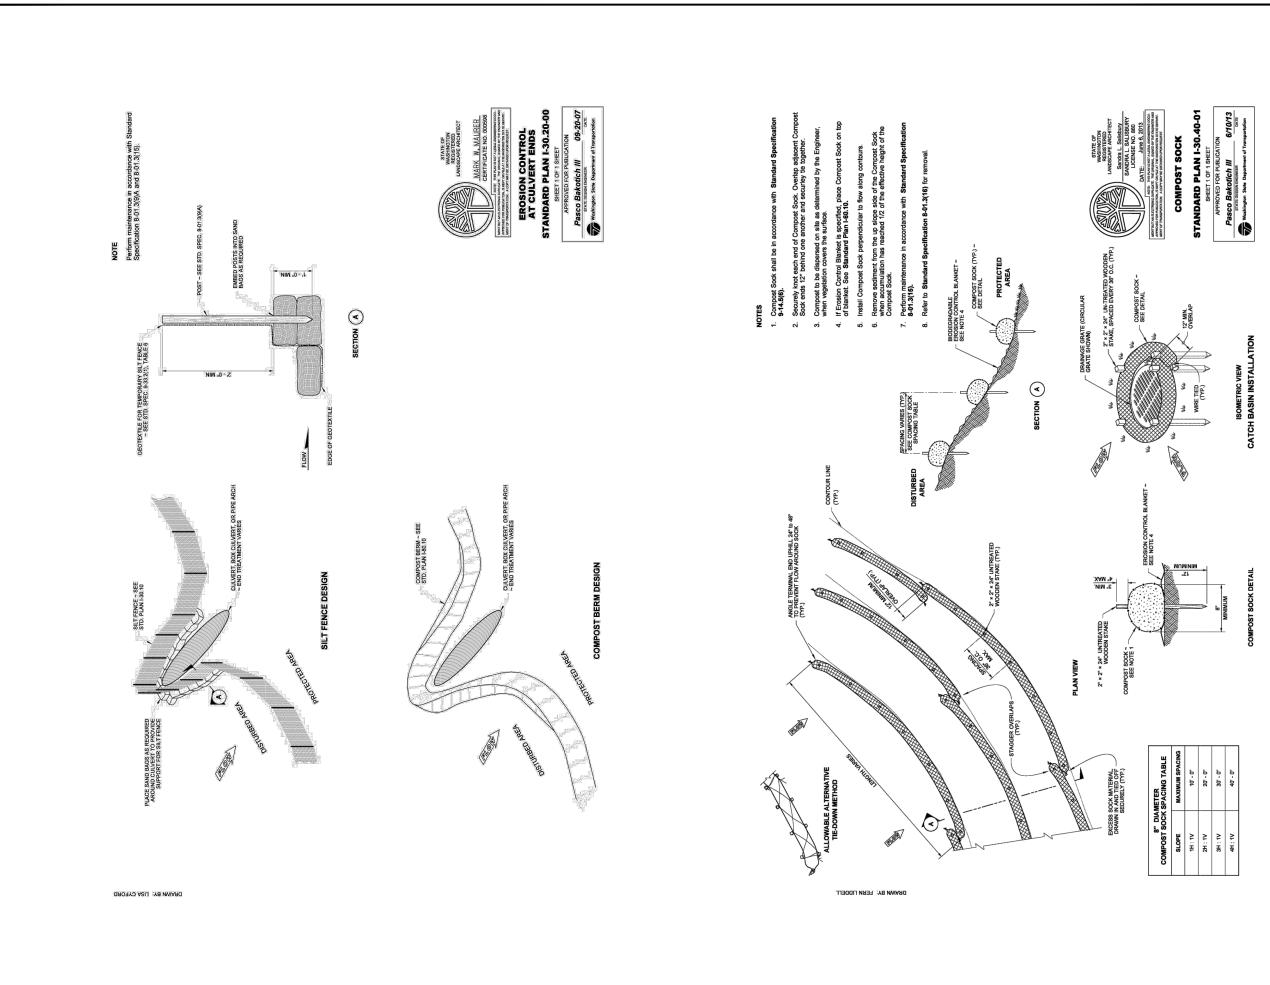
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